


LIGHTING FIXTURE SCHEDULE					
TYPE	MANUFACTURER CATALOG #	LAMP QTY. & TYPE	FIXTURE WATTAGE	VOLTS	DESCRIPTION
DP	JMA-RT(RP-BK / JMA-MOD-2700 / OPL-JMA-20 / JMA-RH-120	LED 7qty	18.813	120	Black aluminum heatsink with frosted lens and round pinnie trim attached to white steel housing
SP	HDL-HO-R-NC-A17-18-120-0-10V(HDL-HP-RA-A17-TL-SLV-SP-279-HEX	LED 9qty	18.7	120	Amerlux Lighting Hornet Series Recessed Adjustable 18w LED downlight unit w/ Spot Optics (trimless)
NF	HDL-HO-R-NC-A17-18-120-0-10V(HDL-HP-RA-A17-TL-SLV-SP-279-HEX	LED 9qty	18.7	120	Amerlux Lighting Hornet Series Recessed Adjustable 18w LED downlight unit w/ Narrow Flood (trimless)
NR	HDL-HO-R-NC-A17-18-120-0-10V(HDL-HP-RA-A17-T-SLW-SP-279-HEX	LED 4qty	18.7	120	Amerlux Lighting Hornet Series Recessed Adjustable 18w LED downlight unit w/ Narrow Flood (white trim)
WR	HDL-HO-R-NC-A17-18-120-0-10V(HDL-HP-RA-A17-T-SLW-SP-279-HEX	LED 18qty	18.7	120	Amerlux Lighting Hornet Series Recessed Adjustable 18w LED downlight unit w/ Medium Flood (White trim)
WFT EM	HDL-HO-R-NC-A17-18-120-0-10V(HDL-HP-RA-A17-T-SLW-SP-279-HEX	LED 18qty	18.7	120	Amerlux Lighting Hornet Series Recessed Adjustable 18w LED downlight unit w/ Medium Flood (White trim), with battery pack
R11	L50-I-12-10-27-80-MULT-9X29	LED 17qty	11.7003	120	EcoSense Lighting Trov Graze Series Linear 1ft. LED wall graze unit w/9x29 degree beam optics
R14	L50-I-48-10-27-80-MULT-9X29	LED 8qty	46.8	120	EcoSense Lighting Trov Graze Series Linear 4ft. LED wall graze unit w/9x29 degree beam optics
R21	L50-I-12-10-27-80-MULT-9X29	LED 3qty	11.7003	120	EcoSense Lighting Trov Graze Series Linear 1ft. LED wall graze unit w/9x29 degree beam optics
R24	L50-I-48-10-27-80-MULT-9X29	LED 7qty	46.8	120	EcoSense Lighting Trov Graze Series Linear 4ft. LED wall graze unit w/9x29 degree beam optics
SL	XD20-25C-27K1050-BK-X-TS	LED 20qty	12.5	120	Power Secure Solais Xd20 Series LED trackhead unit w/25 degree narrow flood optics
T	EPANL-2X4-4000LM-80CRI-35K-MIN 10-ZT-MVOLT	LED 15qty	38.83	120	Lithonia Lighting EPANL Series Recessed 2x4 LED flat panel unit
TE	EPANL-2X4-4000LM-80CRI-35K-MIN 10-ZT-MVOLT	LED 15qty	38.83	120	Lithonia Lighting EPANL Series Recessed 2x4 LED flat panel unit, with battery pack
NV	NF-PRO-0-120-112V24V-2700K	LED 7qty	3	120	NovaFlex Pro 120 Series Linear LED Tape Light (Interior Bar Wall, Exterior Bar Wall, Back Bar)
V	HL-386 / SM16-09-25D-827-03	LED 24qty	9	120	HeviLite HL-386 Series Adjustable Mono-Point LED Flood Unit w/Soraa mr16 LED Lamp
FAN	5WF52BK	3qty	50	120	Monte Carlo Ceiling Fan Company Weatherford series outdoor black fan unit
P1	TBD	2qty	9	120	TO BE DETERMINED Decorative wall mounted glass globe unit
P2	TBD	8qty	9	120	TO BE DETERMINED Decorative brass globe pendant unit
P3	TBD	11qty	100	120	TO BE DETERMINED Large Dome Pendant Unit w/ black trim at the base & G40 black tipped lamp
P4	TBD	7qty	9	120	TO BE DETERMINED Decorative Glass globe pendant unit
P5	TBD	48qty	100	120	TO BE DETERMINED Exposed Bulb Style Pendant Unit (BRASS ROD) w/ G40 and A19 Black Tipped Lamps
P6	LSM241028KF	LED 4qty	60	120	Sival Lighting Decorative String Lighting w/A19 Black Tipped Lamps
X	MANUFACTURER CATALOG # #MODEL PER PLANS	LED GREEN	5.5W	UNV	LED EDGE LIT EXIT SIGN "GREEN" WITH INTEGRAL 90 MINUTE BATTERY UNIT "SELF POWERED"

- LIGHTING FIXTURE NOTES:**
- COORDINATE LIGHT FIXTURE LOCATION AND MOUNTING WITH OTHER EQUIPMENT AND ARCHITECTURAL ELEVATIONS.
 - INSTALL ALL WALL AND SURFACE MOUNTED EXIT SIGN FIXTURES AT THE LOCATION INDICATED AND PROVIDE FACES AND ARROWS AS INDICATED.
 - JUNCTION BOXES SHALL BE PROVIDED FOR ALL EXIT FIXTURES UNLESS FIXTURES ARE APPROVED FOR THROUGH WIRING.
 - SUPPORT LAY-IN TYPE LIGHT FIXTURES INDEPENDENT OF GRID.
 - LIGHT FIXTURES TO BE PROVIDED WITH BALLASTS HAVING LESS THAN 10% TOTAL HARMONIC DISTORTION.
 - CONTRACTOR SHALL PROVIDE ALL LAMPS, ACCESSORIES AND MOUNTING HARDWARE AS REQUIRED.
 - CONTRACTOR SHALL VERIFY EXACT FIXTURE LOCATIONS WITH ARCHITECTURAL REFLECTED CEILING PLANS.
 - CONTRACTOR SHALL VERIFY CEILING TYPES AND PROVIDE TRIMS AND ACCESSORIES AS REQUIRED.
 - PROVIDE DISCONNECTING MEANS FOR FLUORESCENT FIXTURES PER NEC 410.73(G).
 - PROVIDE LIGHT FIXTURES BY MANUFACTURER SPECIFIED OR APPROVED EQUAL. SUBSTITUTED FIXTURES WILL REQUIRE PHOTOMETRIC CALCULATIONS AND MUST PERFORM EQUAL TO OR BETTER THAN LIGHT FIXTURE SPECIFIED. ENGINEER TO MAKE FINAL DETERMINATION.


LIGHTING CONTROL PANEL SPECIFICATIONS

- LIGHTING CONTROL PANEL SHALL BE UL AND CEC CERTIFIED.
- SYSTEM SHALL INCLUDE TIME OF DAY SCHEDULE VIA AN INTERNAL TIME CLOCK.
- INPUTS SHALL ACCEPT EXTERNAL DEVICES SUCH AS PHOTOCELLS, SWITCHES AND OCCUPANCY SENSORS.
- UP TO 48 PROGRAMMABLE SWITCH INPUTS.
- INTEGRAL KEY PAD WITH BACKLIT DISPLAY.
- TIMED SWITCH OVERRIDES FOR A MAXIMUM OF 2 HOURS.
- SYSTEM SHALL HAVE "WARM OFF" FEATURE TO AUTOMATICALLY FLASH "OFF" TO WARN OCCUPANTS BEFORE "WARMING OFF".
- AFTER HOURS SLEEP "OFF" FEATURE LCP SHALL BE ABLE TO PROGRAM 365 DAYS + HOLIDAYS, ETC.
- LIGHTING CONTROL PANEL SHALL BE MANUFACTURED BY WATTSTOPPER OR LCAD OR EQUAL.
- LIGHTING CONTROL PANEL SHALL HAVE INTEGRAL BYPASS FUNCTION FOR NORMAL LIGHTING POWER FAIL.

- AUTOMATIC LIGHTING CONTROL PANEL USED TO CONTROL (OUTDOOR) LIGHTING SHALL:
- BE CAPABLE OF PROGRAMMING DIFFERENT SCHEDULES FOR WEEKDAYS AND WEEKENDS; AND
 - HAVE PROGRAM BACKUP CAPABILITIES THAT PREVENT THE LOSS OF THE DEVICES PROGRAM AND TIME SETTING FOR AT LEAST 10 HOURS IF POWER IS INTERRUPTED.
 - CONTAIN AT LEAST 3 SEPARATELY PROGRAMMABLE CHANNELS PER FUNCTION AREA; AND
 - HAVE THE ABILITY TO INDEPENDENTLY OFFSET THE ON AND OFF TIMES FOR EACH CHANNEL BY 0 TO 99 MINUTES BEFORE OR AFTER SUNRISE OR SUNSET; AND
 - HAVE SUNRISE AND SUNSET PREDICTION ACCURACY WITHIN +/- 5 MINUTES AND TIMEKEEPING ACCURACY WITHIN 5 MINUTES PER YEAR; AND
 - STORE TIME ZONE, LONGITUDE AND LATITUDE IN NON-VOLATILE MEMORY; AND
 - DISPLAY DATE, TIME, SUNRISE AND SUNSET; AND
 - HAVE AN AUTOMATIC DAYLIGHT SAVING TIME ADJUSTMENT; AND
 - HAVE AUTOMATIC TIME SWITCH CAPABILITIES INCLUDING 365 DAY, ASTRONOMICAL TIME CLOCK.

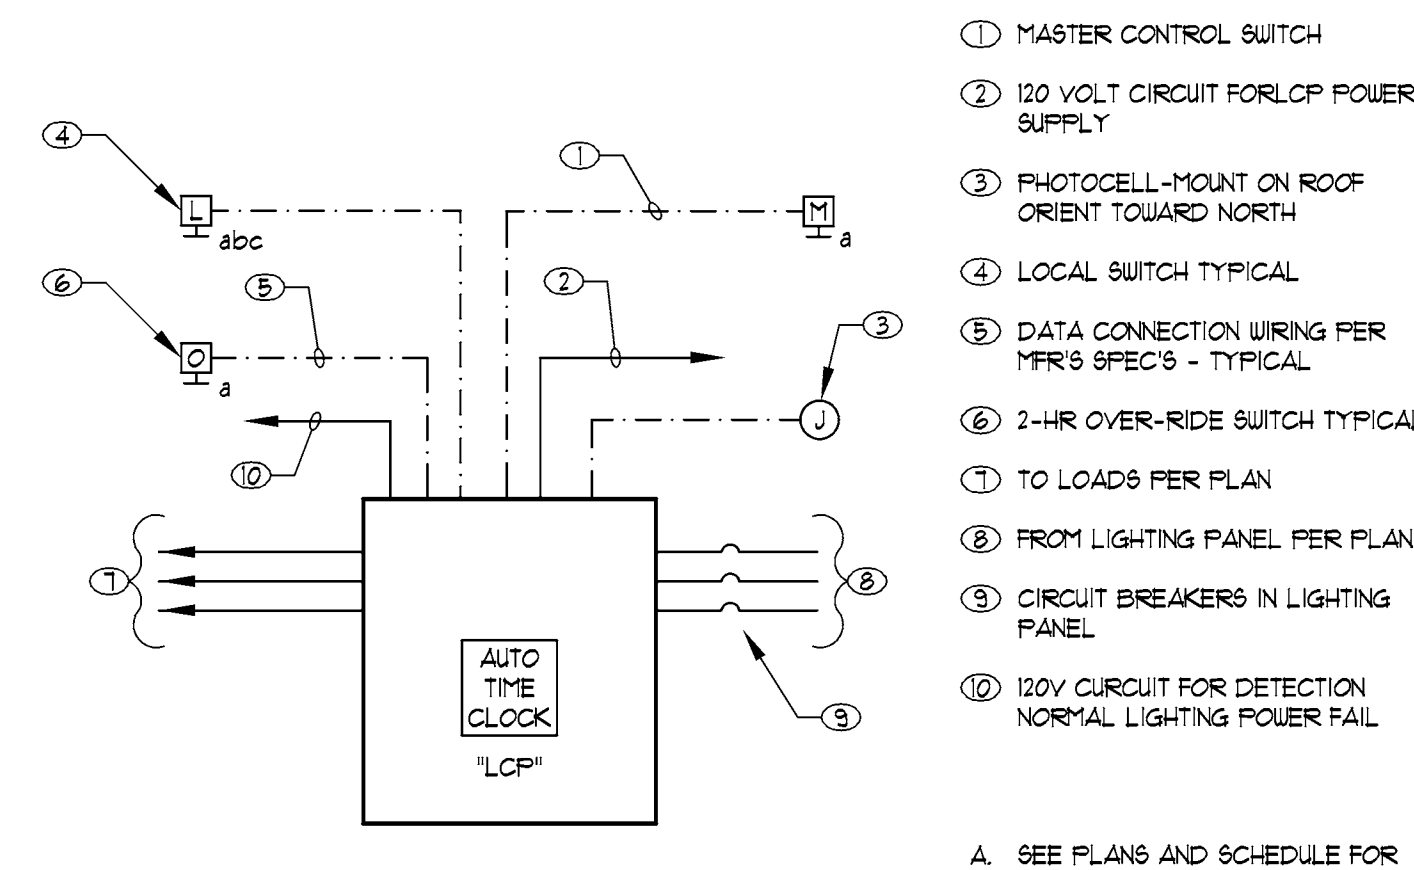


- MASTER CONTROL SWITCH
 - 120 VOLT CIRCUIT FOR LCP POWER SUPPLY
 - PHOTOCELL-MOUNT ON ROOF ORIENT TOWARD NORTH
 - LOCAL SWITCH TYPICAL
 - DATA CONNECTION WIRING PER IFC'S SPEC'S - TYPICAL
 - 2-HR OVER-RIDE SWITCH TYPICAL
 - TO LOADS PER PLAN
 - FROM LIGHTING PANEL PER PLAN
 - CIRCUIT BREAKERS IN LIGHTING PANEL
 - 120V CIRCUIT FOR DETECTION NORMAL LIGHTING POWER FAIL
- A. SEE PLANS AND SCHEDULE FOR QUANTITY AND LOCATION OF SWITCHES.

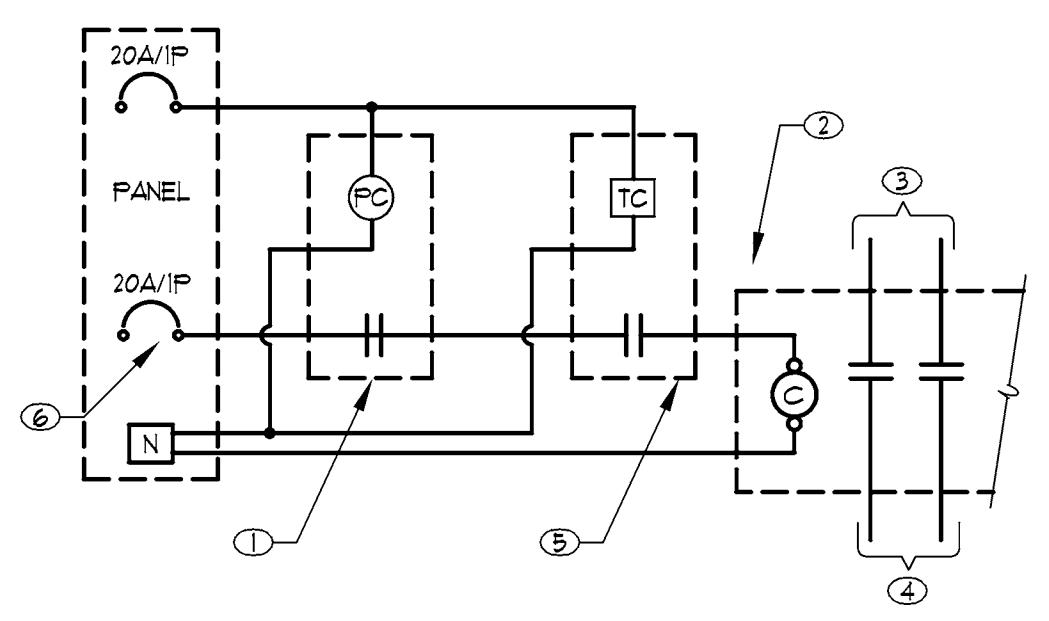

02 EXTERIOR LIGHTING CONTROL DIAGRAM
XXX-XXXXX NO SCALE

- PHOTOCELL ON ROOF - ORIENTATE FACING NORTH
 - RELAY (EXTERIOR LIGHTS & SIGNS) ELECTRICALLY HELD (PHOTOCELL ON TIMELOCK OFF)
 - TO LIGHTING CIRCUITS
 - TO LIGHTING LOADS
 - 24 HOUR DIAL TIMELOCK WITH ASTRO DIAL PARAGON #A003-206Z (TYPICAL)
 - REFER TO PANEL SCHEDULE FOR BRANCH CIRCUIT NUMBER
- A. MOUNT RELAYS ADJACENT TO PANEL

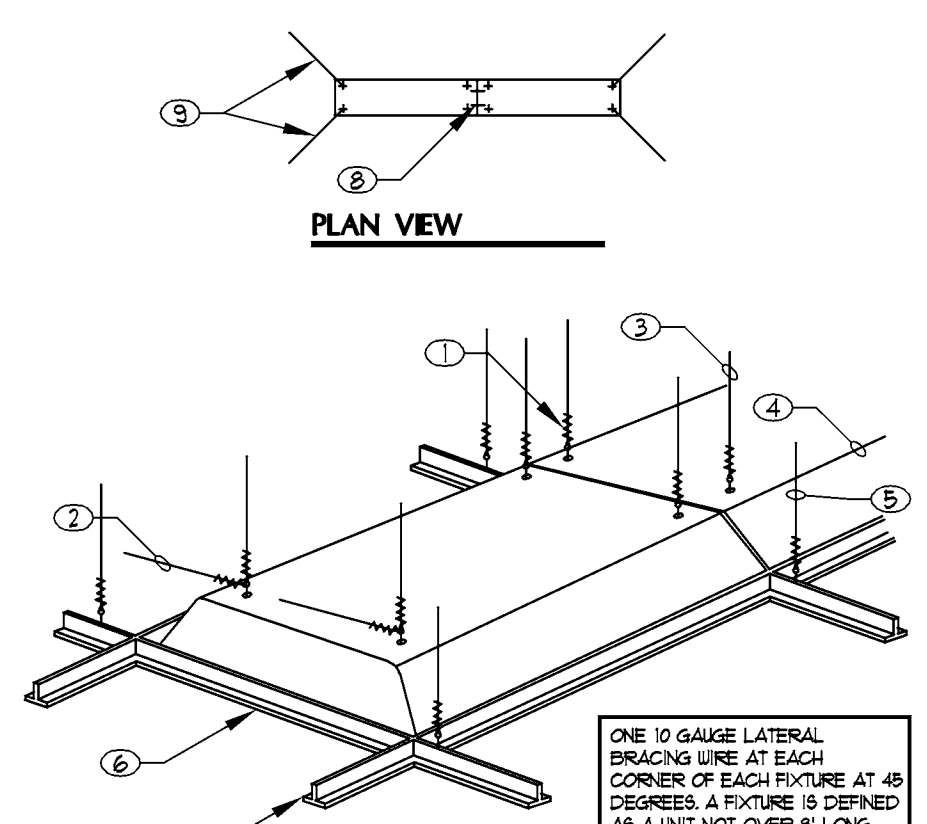

01 RECESSED LIGHTING FIXTURE MOUNTING DETAIL
XXX-XXXXX NO SCALE

- TYPICAL 1/4" CLOSED EYE BOLT - 4 PER 4' FIXTURE. OMIT EYE BOLT WHEN FIXTURE IS EQUIPPED WITH MOUNTING STRAPS
- ONE (2) GAUGE LATERAL BRACING WIRE AT EACH CORNER OF EACH FIXTURE AT 45 DEGREES. A FIXTURE IS DEFINED AS A UNIT NOT OVER 8' LONG.
- GALVANIZED SOFT IRON WIRE #12 GAUGE MIN. AT EACH CORNER OF A 4' FIXTURE FOUR FULL WRAPS AT TOP AND BOTTOM. WIRES SHALL BE PAINTED "RED" COLOR.
- RECESSED FLUORESCENT FIXTURE
- #2 WIRE ON T-BAR MAIN RUNNER WITHIN 3" OF FOUR CORNERS OF LIGHT FIXTURES
- MAIN RUNNER
- CROSS TEE
- BOLT WITH #6 - 32 MACHINE SCREW 1/40 PER JUNCTION
- LATERAL BRACING AT 45 DEGREE

03 LIGHTING CONTROL PANEL WIRING DIAGRAM
XXX-XXXXX NO SCALE

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3850 WORSHAM BOULEVARD
SUITE 410, BUILDING R-4
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Sheet Title:
LIGHTING SCHEDULES, DIAGRAMS AND DETAILS

Sheet Number:
E102

ENCLOSURE

STATE OF CALIFORNIA INDOOR LIGHTING POWER ALLOWANCE CERTIFICATE OF COMPLIANCE... PROJECT: The 908... DATE: 9/18/2018... SECTION: 9/18/2018... SECTION: 9/18/2018...

STATE OF CALIFORNIA INDOOR LIGHTING - LIGHTING CONTROLS... PROJECT: The 908... DATE: 9/18/2018... SECTION: 9/18/2018... SECTION: 9/18/2018...

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CA Building Energy Efficiency Standards - 2016 Nonresidential Compliance April 2016

CA Building Energy Efficiency Standards - 2016 Nonresidential Compliance January 2016

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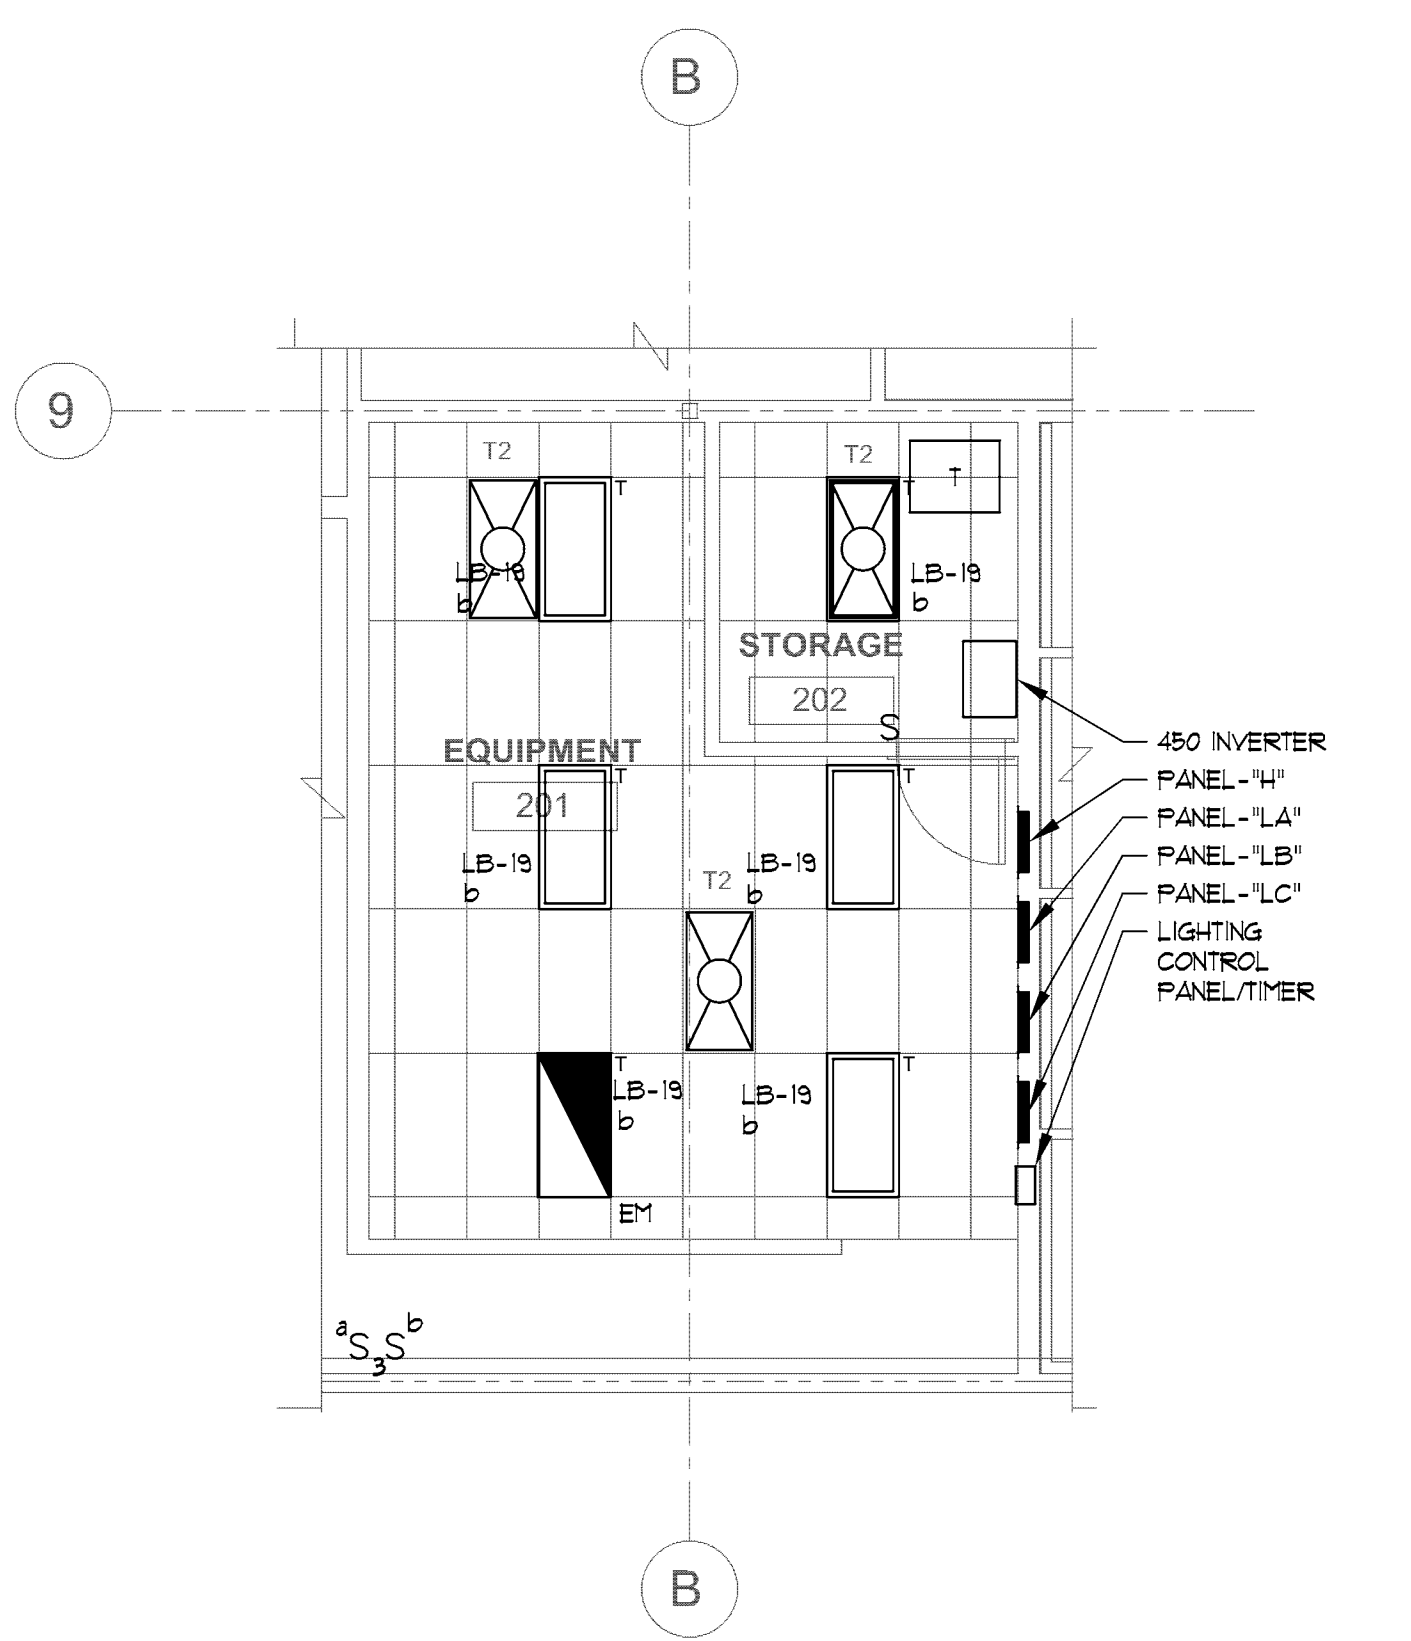
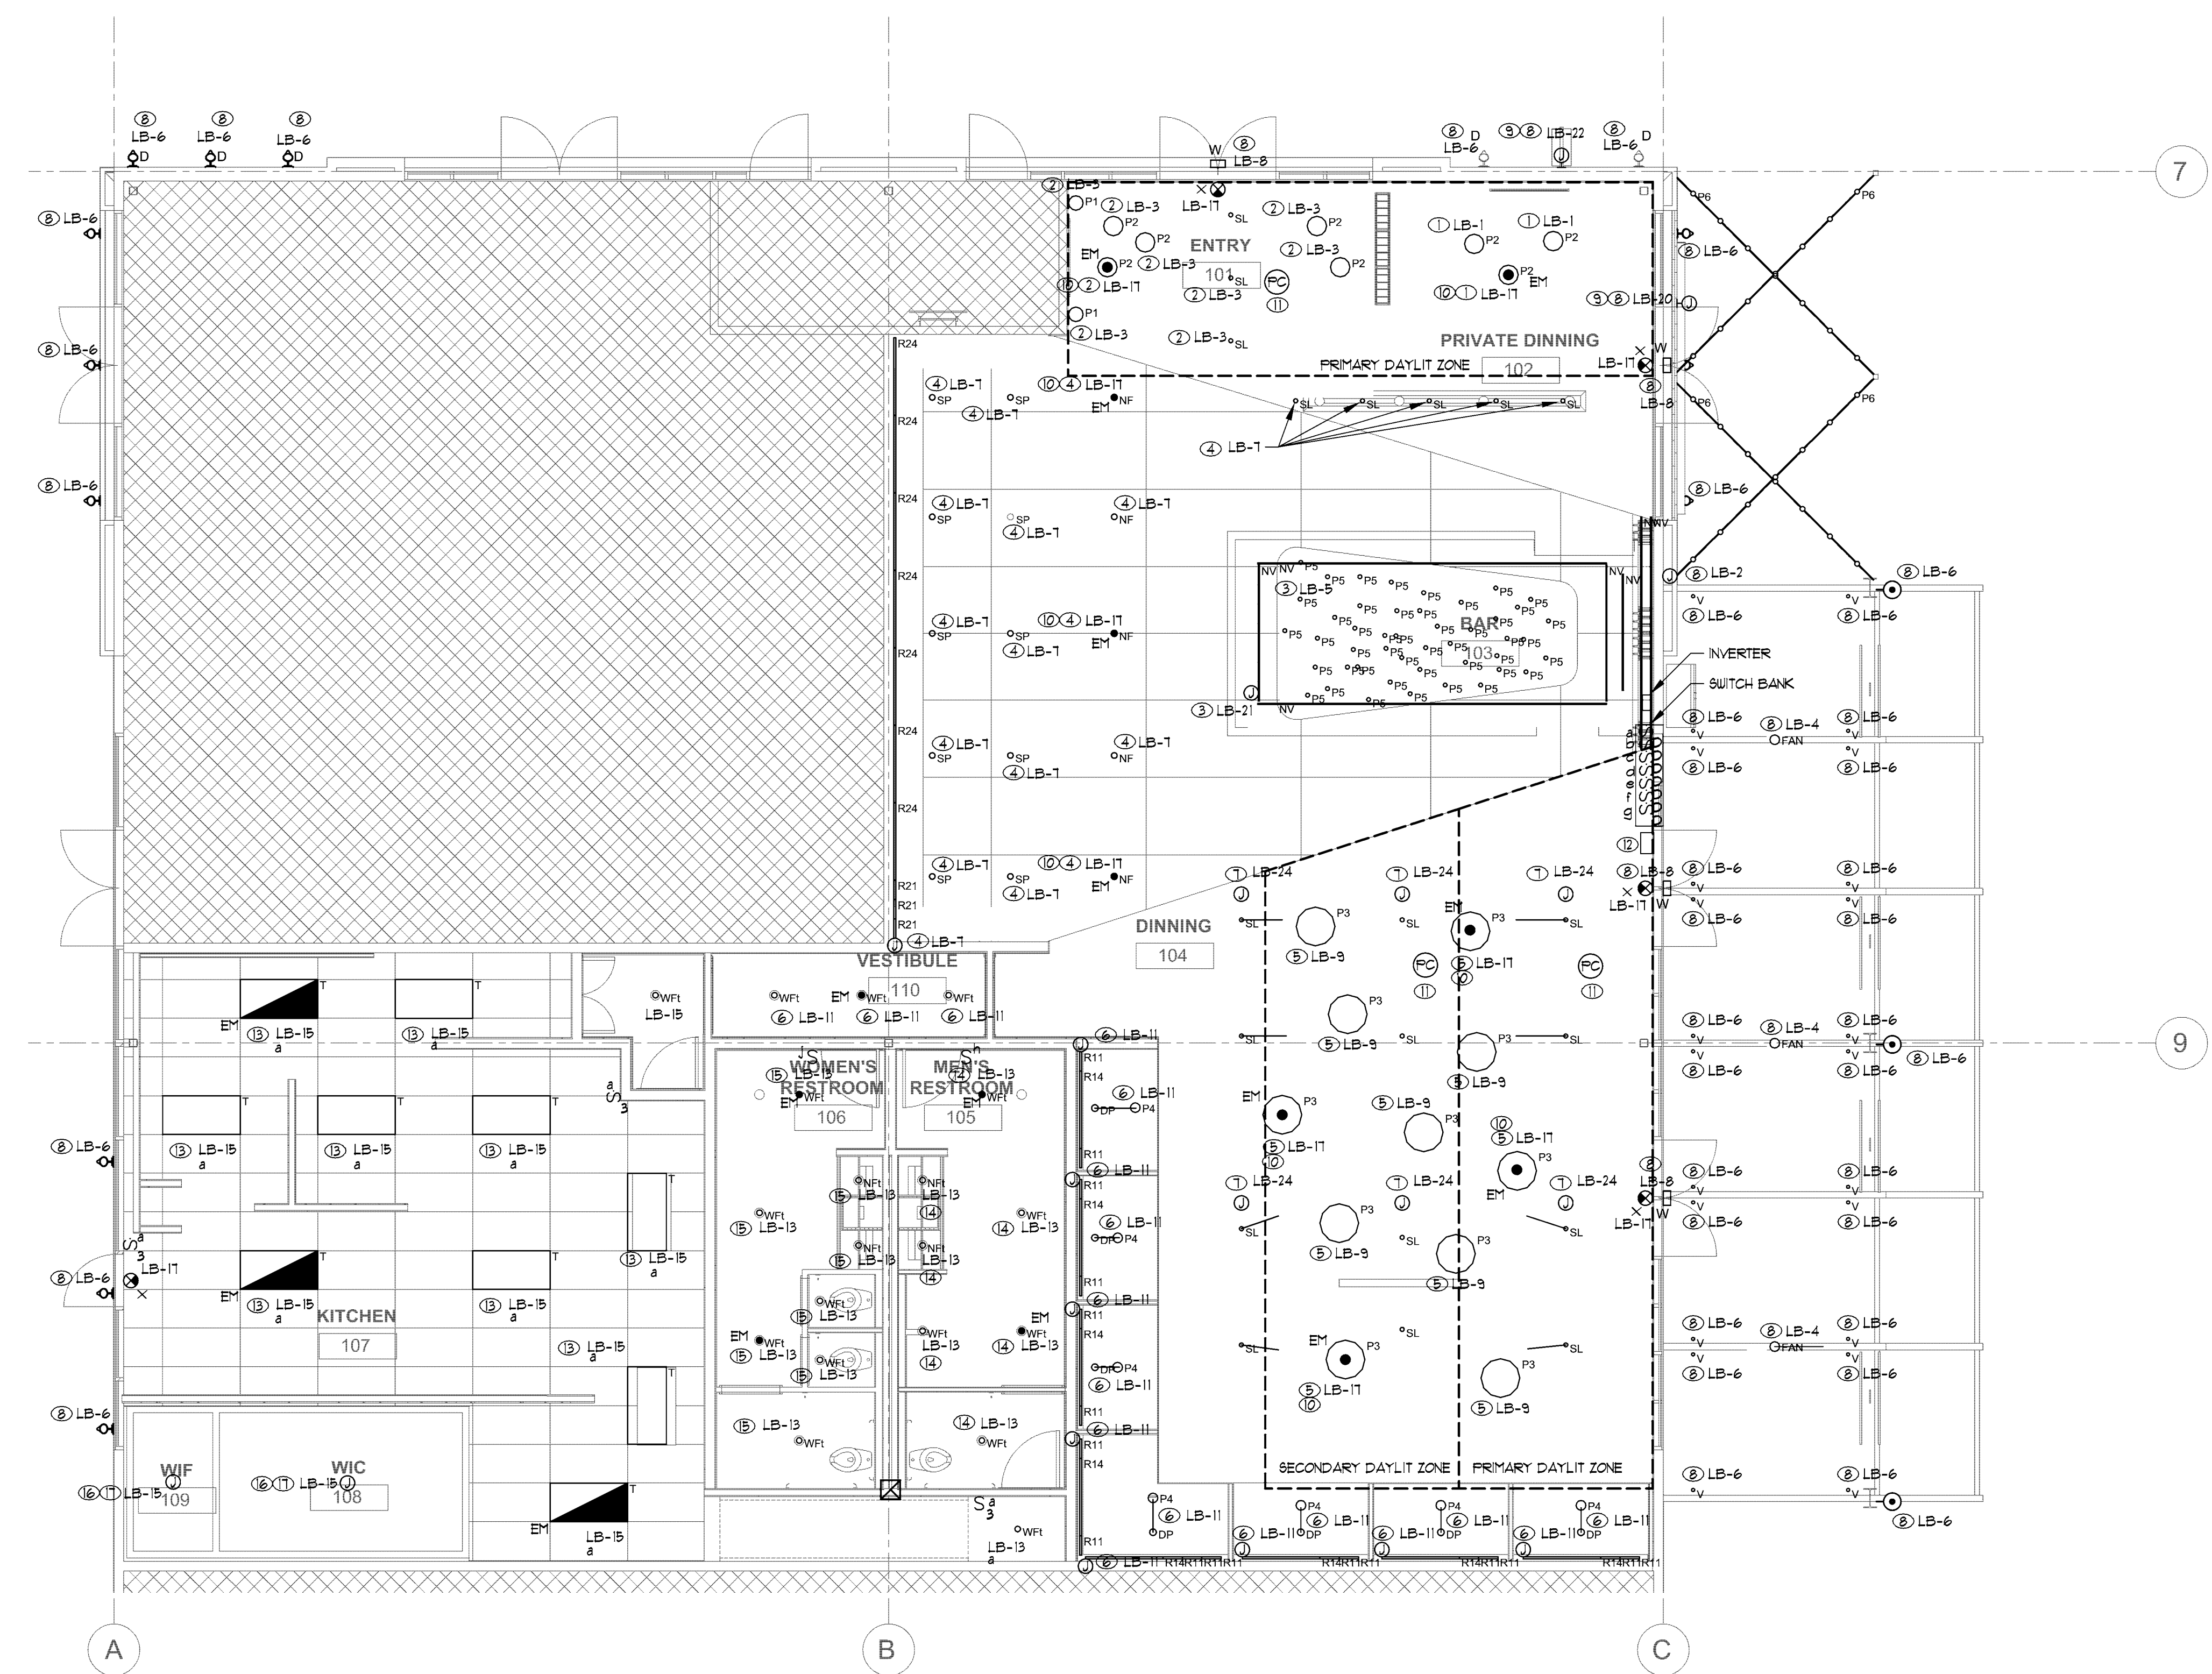
LIGHTING PLAN GENERAL NOTES (AS APPLICABLE)

- A. PROVIDE A DISCONNECTING MEANS FOR EACH MULTI-WIRE LIGHTING BRANCH CIRCUIT IN ACCORDANCE WITH 410.30(G)(1) THRU (3). DISCONNECTING MEANS SHALL BE LOCATED AT POINT WHERE CIRCUIT ORIGINATES AND SHALL SIMULTANEOUSLY DISCONNECT ALL UNGROUNDED CONDUCTORS.
- B. REFER TO ARCHIT. REFLECTED CEILING PLAN FOR EXACT LOCATION OF ALL LIGHTING FIXTURES.
- C. VERIFY EXACT CEILING CONSTRUCTION W/ ARCHIT. REFLECTED CEILING PLAN AND PROVIDE LIGHTING FIXTURES W/ ALL NECESSARY MOUNTING HARDWARE.
- D. COORDINATE EXACT LIGHTING FIXTURE LOCATIONS W/ MECHANICAL EQUIPMENT AND DUCT WORK PRIOR TO ROUGH-IN.
- E. ALL RECESSED FIXTURES SHALL BE PROVIDED W/ ALL REQUIRED STRUCTURAL SUPPORTS AS REQUIRED BY CURRENTLY ACCEPTED EDITION OF ALL APPLICABLE NATIONAL, STATE, AND CITY CODES, ORDINANCES, AND AMENDMENTS.
- F. ALL DIMMING BRANCH CIRCUITS SHALL BE PROVIDED W/ A DEDICATED NEUTRAL CONDUCTOR FOR EACH ZONE/CHANNEL.
- G. ALL FLUORESCENT DIMMING ZONES/CHANNELS SHALL BE PROVIDED W/ 3 LINE VOLTAGE CONDUCTORS (NEUTRAL, DIMMED HOT, SWITCHED HOT) OR 2 LINE VOLTAGE CONDUCTORS/CONTROL CONDUCTORS AS REQUIRED BY THE CONTROL/BALLAST TYPE.
- H. ALL EMERGENCY BATTERY PACK FIXTURES AND NITE LIGHT FIXTURES SHALL BE PROVIDED WITH AN UNSWITCHED CONSTANT HOT CONNECTION TO THE CHARGING LEAD.
- I. REFER TO ARCHITECTURAL REFLECTED CEILING PLANS FOR EXIT SIGN CHEVRONS AND NUMBER OF FACES PER EXIT SIGN. ANY DISCREPANCIES BETWEEN EXIT SIGNS SHOWN ON THE ELECTRICAL AND ARCHITECTURAL PLANS SHALL BE BROUGHT TO THE ATTENTION OF THE ARCHITECT PRIOR TO ORDERING EXIT SIGNS.
- J. ALL ELECTRICAL EQUIPMENT LOCATED OUTSIDE SHALL BE WEATHERPROOF.
- K. ALL LOW VOLTAGE WIRING **NOT** RUN IN CONDUIT SHALL BE FLEXTM RATED.
- L. PROVIDE UNIFORM DUAL LEVEL SWITCHING OF LIGHTS IN ROOMS WHERE TWO SWITCHES ARE SHOWN CONNECTED TOGETHER. CONTRACTOR TO PROVIDE ALL NECESSARY CONDUCTORS FOR ALL DUAL SWITCHING APPLICATIONS AS SHOWN ON PLAN.
- M. CONTRACTOR TO PROVIDE ALL NECESSARY TRAVELER CONDUCTORS FOR ALL 3 AND 4 WAY SWITCHING APPLICATIONS.
- N. ALL EXTERIOR BUILDING MOUNTED LIGHTING SHALL BE 2"Ø, M0 GND IN A 3/4"Ø UNO.
- O. GENERAL CONTRACTOR SHALL VERIFY CEILING FIRE RATING WITH ARCHITECT AND BOX OR TENT ALL RECESSED LIGHT FIXTURES, IF REQUIRED, TO MAINTAIN CEILING FIRE RATING.
- P. ALL PENETRATIONS THROUGH FIRE RATED WALLS SHALL BE PROTECTED FROM THE SPREAD OF FIRE WITH AN APPROVED FIRESTOP SYSTEM EQUAL OR GREATER THAN THE FIRE RATING OF THE WALL.
- Q. ALL LIGHT FIXTURES W/ EMERGENCY BATTERY PACKS AND NITE LIGHTS TO BE PROVIDED W/ A CONSTANT UN-SWITCHED CONDUCTOR IN ADDITION TO THE SWITCHED CIRCUIT CONDUCTOR. SWITCHING TO BE PROVIDED AS SHOWN ON PLAN.
- R. LIGHT FIXTURES IN FOOD PREP AREAS SHALL BE ENCLOSED, GASKETED WITH 0.125" MINIMUM ACRYLIC LENS AND/OR FLUORESCENT LAMPS PROVIDED WITH SHATTER PROOF SLEEVES.
- S. ALL EMERGENCY EGRESS LIGHTING SHALL BE PROVIDED W/ A MINIMUM 90 MINUTE BATTERY BACKUP.
- T. REFER TO ARCHITECTURAL ELEVATIONS FOR LOCATIONS OF EXTERIOR LIGHTING AND SIGNAGE REQUIREMENTS.
- U. PROVIDE UNCONTROLLED HOT WIRES FROM LIGHTING CIRCUITS FOR EXIT SIGN, EMERGENCY LIGHTS, AND LIGHTING CONTROL DEVICES.

LIGHTING PLAN KEYNOTES


- ① TO DIMMER SWITCH BANK a, AND THROUGH LIGHTING CONTROL PANEL/TIMER CONTROL.
- ② TO DIMMER SWITCH BANK b, AND THROUGH LIGHTING CONTROL PANEL/TIMER CONTROL.
- ③ TO DIMMER SWITCH BANK c AND THROUGH LIGHTING CONTROL PANEL/TIMER CONTROL.
- ④ TO DIMMER SWITCH BANK d, AND THROUGH LIGHTING CONTROL PANEL/TIMER CONTROL.
- ⑤ TO DIMMER SWITCH BANK e, AND THROUGH LIGHTING CONTROL PANEL/TIMER CONTROL.
- ⑥ TO DIMMER SWITCH BANK f, AND THROUGH LIGHTING CONTROL PANEL/TIMER CONTROL.
- ⑦ TO DIMMER SWITCH BANK g, AND THROUGH LIGHTING CONTROL PANEL/TIMER CONTROL.
- ⑧ TO THE CLOCK & PHOTOCELL CONTROL.
- ⑨ BUILDING SIGNAGE THROUGH TIMER & PHOTOCELL CONTROL.
- ⑩ CONNECT LIGHTING FIXTURES THROUGH EMERGENCY INVERTER 120V 600J MINIMUM AND LIGHTING CONTROLS, FIXTURES ARE FULLY ON WHEN POWER FAIL.
- ⑪ DAY LIGHT SENSOR FOR DAY LIGHT AREA CONTROL.
- ⑫ 2-HR OVERRIDE SWITCH.
- ⑬ TO SPD, TIMER.
- ⑭ TO SPD, TIMER.
- ⑮ TO SPD, TIMER.
- ⑯ WALK IN BOX LIGHTS AND SWITCHES SHALL BE PROVIDED BY MANUFACTURE, PROVIDE CONTROL RELAY FOR WALK IN LIGHTS FOR AUTOMATIC SHUT OFF CONTROL.
- ⑰ PROVIDE SEALS & EXPANSION COUPLINGS ON ALL CONDUITS ENTERING OR LEAVING A DIFFERENCE IN TEMPERATURE.

NOTE: ELECTRICAL CONTRACTOR TO INCLUDE IN THE BIDD AND PART OF THE SCOPE OF WORK ELECTRICAL RELATED REQUIREMENTS NOT SHOWN ON THIS PLAN BUT ARE SHOWN NOTED IN THE ARCHITECTURAL/CIVIL/HVAC AND PLUMBING DRAWINGS.



LIGHTING FLOOR PLAN - EQUIPMENT PLATFORM
SCALE: 3/16" = 1'-0"

LIGHTING FLOOR PLAN
SCALE: 3/16" = 1'-0"

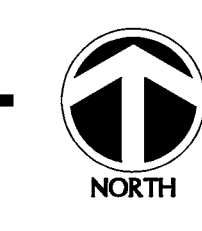

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BOULEVARD
SUITE 410, BUILDING R-4
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Sheet Title:
LIGHTING
FLOOR PLAN

Sheet Number:
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FIRE SUPPRESSION REQUIREMENTS

- A. WHEN THE FIRE SUPPRESSION SYSTEM IS DISCHARGED, THE FOLLOWING ACTIONS MUST TAKE PLACE:
 1. ALL ELECTRICAL RECEPTACLES AND COOKING APPLIANCES UNDER HOOD MUST BE SHUT DOWN.
 2. EXHAUST FANS MUST STAY ON. REFER TO MECHANICAL DRAWINGS FOR WIRING DIAGRAM.
 3. MAKE UP AIR MUST SHUT OFF. REFER TO MECHANICAL DRAWINGS FOR WIRING DIAGRAM.
 4. ALL GAS SUPPLIED TO COOKING EQUIPMENT UNDER HOOD TO BE SHUT OFF VIA THE GAS SHUT-OFF VALVE. SEE PLUMBING DRAWINGS FOR INFORMATION.
- B. THE FIRE ALARM SHALL BE TIED TO THE ANSUL SYSTEM.
- C. MANUAL RESET RELAY MICRO SWITCH FBO, SHALL BE CONNECTED TO GAS VALVE BY ELECTRICAL. REFER TO FIRE SYSTEM SPECIFICATIONS.
- D. SEE ANSUL SYSTEM WIRING DIAGRAM FOR INFORMATION. SEE CAFE R/C #31002, BUI #30796 FOR ANSUL DETAIL.

POWER PLAN GENERAL NOTES (AS APPLICABLE)

- A. VERIFY EXACT LOCATIONS AND MOUNTING HEIGHT OF ALL ELECTRICAL OUTLETS AND DEVICES w/ KITCHEN EQUIPMENT SUPPLIER PRIOR TO ROUGH-IN.
- B. ALL ELECTRICAL WIRING RUNS SHALL BE CONCEALED IN WALLS, FLOOR, CEILING OR COUNTERS.
- C. ALL 120V SINGLE PHASE, 20 AMP RECEPTACLES INSTALLED IN THE KITCHEN, BATHROOM AND ON THE ROOF SHALL HAVE GROUND-FAULT CIRCUIT-INTERRUPTER PROTECTION PER NEC.
- D. ELECTRICAL CONTRACTOR SHALL PROVIDE AND INSTALL ALL JUNCTION AND PULL BOXES REQUIRED FOR THE INSTALLATION OF ELECTRICAL DEVICES AND EQUIPMENT WHETHER OR NOT SPECIFICALLY INDICATED ON PLANS. SIZING OF BOXES SHALL BE PER NEC.
- E. ALL CONDUIT PASSING THROUGH WALL OF COOLER/FREEZER SHALL BE PROVIDED WITH EYE FITTINGS.
- F. CONDUITS THAT ARE EXPOSED TO WIDELY DIFFERENT TEMPERATURES, SUCH AS COOLERS, FREEZERS, DIRECT SUN OR SERVICE ENTRANCE CONDUIT, SHALL BE SEALED TO PREVENT CIRCULATION OF AIR AND/OR MOISTURE.
- G. IN ALL KITCHEN FOOD PREP, DISHWASHING, AND SERVING AREAS, PROVIDE STAINLESS STEEL OUTLET COVER PLATES. IN ALL OTHER AREAS, MATCH ADJACENT FINISH COLOR. COORDINATE w/ ARCHITECT.
- H. ALL EQUIPMENT SHALL BE HARDWIRED w/ AN APPROVED DISCONNECTING MEANS UNLESS EQUIPMENT IS SUPPLIED w/ A FACTORY INSTALLED CORD AND PLUG.
- I. ELECTRICAL CONTRACTOR TO VERIFY ALL POWER REQUIREMENTS AND LOCATIONS OF FOOD SERVICE EQUIPMENT w/ FOOD SERVICE CONTRACTOR PRIOR TO ROUGH-IN.
- J. ALL RECEPTACLES ON COMMON WALLS SHALL BE SEPARATE BOXES AND OFFSET (2" MINIMUM). FIRE RATED WALLS SHALL HAVE AN OFFSET OF 24" MINIMUM. COORDINATE w/ ARCHIT. FIRE RATED WALL DETAILS.
- K. ALL PENETRATIONS THROUGH FIRE-RATED WALLS SHALL BE PROTECTED FROM THE SPREAD OF FIRE w/ AN APPROVED FIRESTOP SYSTEM, EQUAL OR GREATER THAN THE FIRE RATINGS OF THE WALL.
- L. HEIGHT OF ALL RECEPTACLES AT COUNTER SHELVES, ETC. SHALL BE VERIFIED w/ OWNER PRIOR TO ROUGH-IN. PROVIDE GFCI TYPE RECEPTACLE WITHIN 6 FEET OF ANY GFCI.
- M. ALL UNDERGROUND CONDUITS SHALL BE PVC SCHED. 40, MINIMUM 3/4" I.D., RUN CODE 912 INSULATED EQUIPMENT GROUND CONDUCTOR.
- N. EACH AND EVERY 15 AND 20 AMP, 120 VOLT RECEPTACLE IN KITCHEN, FOOD PREP, BAR AREAS AND RESTROOMS SHALL BE GFCI TYPE PROTECTION.


SIGNAL PLAN GENERAL NOTES

- A. CONDUITS SHALL CONTAIN NO CONTINUOUS SECTIONS LONGER THAN 100 FT. AND NO MORE THAN (2) 90 DEGREE BENDS OR (1) REVERSE BEND WITHOUT INSTALLING A PULL BOX. CONDUITS IN PLACE OF PULL BOXES ARE UNACCEPTABLE.
- B. CONDUITS SHALL CONTAIN PLASTIC OR NYLON PULL TAPE RATED AT 20 LBS.
- C. CONDUIT BEND RADIUS SHALL BE (A) A MINIMUM OF 6 TIMES OF THE INTERNAL CONDUIT DIAMETER FOR CONDUITS 2" IN DIAMETER OR LESS, AND (B) 10 TIMES THE INTERNAL CONDUIT DIAMETER FOR CONDUITS MORE THAN 2" IN DIAMETER.
- D. TERMINATE CONDUITS THAT PENETRATE THROUGH STRUCTURAL FLOORS 3" ABOVE THE FLOOR SURFACE.
- E. INSTALL BUSHINGS AND BELL ENDS AS REQUIRED ON ALL CONDUITS.
- F. FLEX CONDUIT IS GENERALLY UNACCEPTABLE FOR USE AS A COMMUNICATIONS CONDUIT EXCEPT AT SEISMIC JOINTS AND AS APPROVED IN WRITINGS BY THE ENGINEER.
- G. ALL SUBSLAB CONDUITS SHALL BE INSTALLED IN A MANNER THAT PREVENTS WATER INFILTRATION OF THE CONDUIT. IT IS THE CONTRACTOR'S RESPONSIBILITY TO ENSURE RAIN WATER OR CONSTRUCTION WATER IS PREVENTED FROM ENTERING AND/OR REMOVED FROM THE CONDUITS PRIOR TO PLACEMENT OF COMMUNICATION CABLES.
- H. ALL PULL BOXES SHALL BE SIZED AND INSTALLED PER ANSI/TIA/EIA-569A. PULL BOXES FOR UNDER FLOOR CONDUIT RUNS ARE NOT PERMITTED UNLESS OTHERWISE NOTED. PULL BOXES FOR OVERHEAD CONDUIT RUNS SHALL BE LOCATED ABOVE ACCESSIBLE CEILING WITHIN THE ACCESSIBLE CEILING SPACE.
- I. CONDUITS SHALL EXIT A PULL BOX ON THE WALL OPPOSITE THE WALL ENTERED.
- J. IF FIRE ALARM DEVICES ARE INDICATED ON PLANS, THEN THE ELECTRICAL CONTRACTOR SHALL SUBMIT FIRE ALARM PLANS AND OBTAIN APPROVAL PRIOR TO INSTALLATION.
- K. SEE ARCHITECTURAL AND KITCHEN CONSULTANT SHEETS FOR EXACT LOCATIONS OF POWER AND DATA RECEPTACLES.

KEYNOTES

- 1 PROVIDE J-BOX FOR PATIO HEATER MODEL #3402023 TUNGSTEN SMART-HEAT ELECTRIC
- 2 UNDERGROUND CONDUITS FOR POWER AND TELE/DATA, CUT AND PATCH FLOOR AS REQUIRED. COORDINATE FLOOR CUTTING WITH LANDLORD PRIOR TO STARTING WORK.
- 3 CONNECT TO HOOD LIGHTS, ANSUL SYSTEM VENTILATION CONTROL, ELECTRICALLY OPERATED GAS VALVES, ETC. AS REQUIRED.
- 4 PROVIDE ELECTRICALLY HELD GAS VALVES. SEE PLUMBING DRAWING FOR GAS SHUT OFF VALVE EXACT LOCATION.
- 5 ELECTRICAL CONTRACTOR TO PROVIDE SHUNT TRIP BREAKERS FOR ALL EQUIPMENT UNDER HOOD AND INTERLUDE TO FIRE PROTECTION SYSTEM PER LOCAL CODE. PROVIDE DEDICATE NEUTRAL FOR ALL CIRCUITS WITH SHUNT TRIP BREAKERS.
- 6 HOOD LIGHT, FAN CONTROL STATION AND ANSUL CONTROL PANEL. VERIFY FINAL LOCATION ON FIELD WITH ARCHITECT/OWNER.
- 7 PROVIDE SEALS & EXPANSION COUPLINGS ON ALL CONDUITS ENTERING OR LEAVING A DIFFERENCE IN TEMPERATURE.
- 8 CONTRACTOR TO VERIFY WITH OWNER FOR FINAL W/ BOX MANUFACTURER AND MODEL. COORDINATE WITH MANUFACTURER FOR W/ BOX, FAN, LIGHT, HEATER, COMPRESSOR WIRING AND POWER REQUIREMENTS. INCLUDE ALL COP'S IN BIDDING.
- 9 3/4" C, 3" O - 10 G.
- 10 RUN 1" CONDUIT WITH FULL STRING FROM BUILDING MAIN TELEPHONE BOARD TO TENANT 2'X2'X1/4" THICK PLYWOOD TELE BKBD MOUNTED ON WALL. VERIFY WITH OWNER FOR REQUIREMENTS.

NOTE: ELECTRICAL CONTRACTOR TO INCLUDE IN THE BID AND PART OF THE SCOPE OF WORK ELECTRICAL RELATED REQUIREMENTS NOT SHOWN ON THIS PLAN BUT ARE SHOWN/NOTED IN THE ARCHITECTURAL/CIVIL/HVAC AND PLUMBING DRAWINGS.

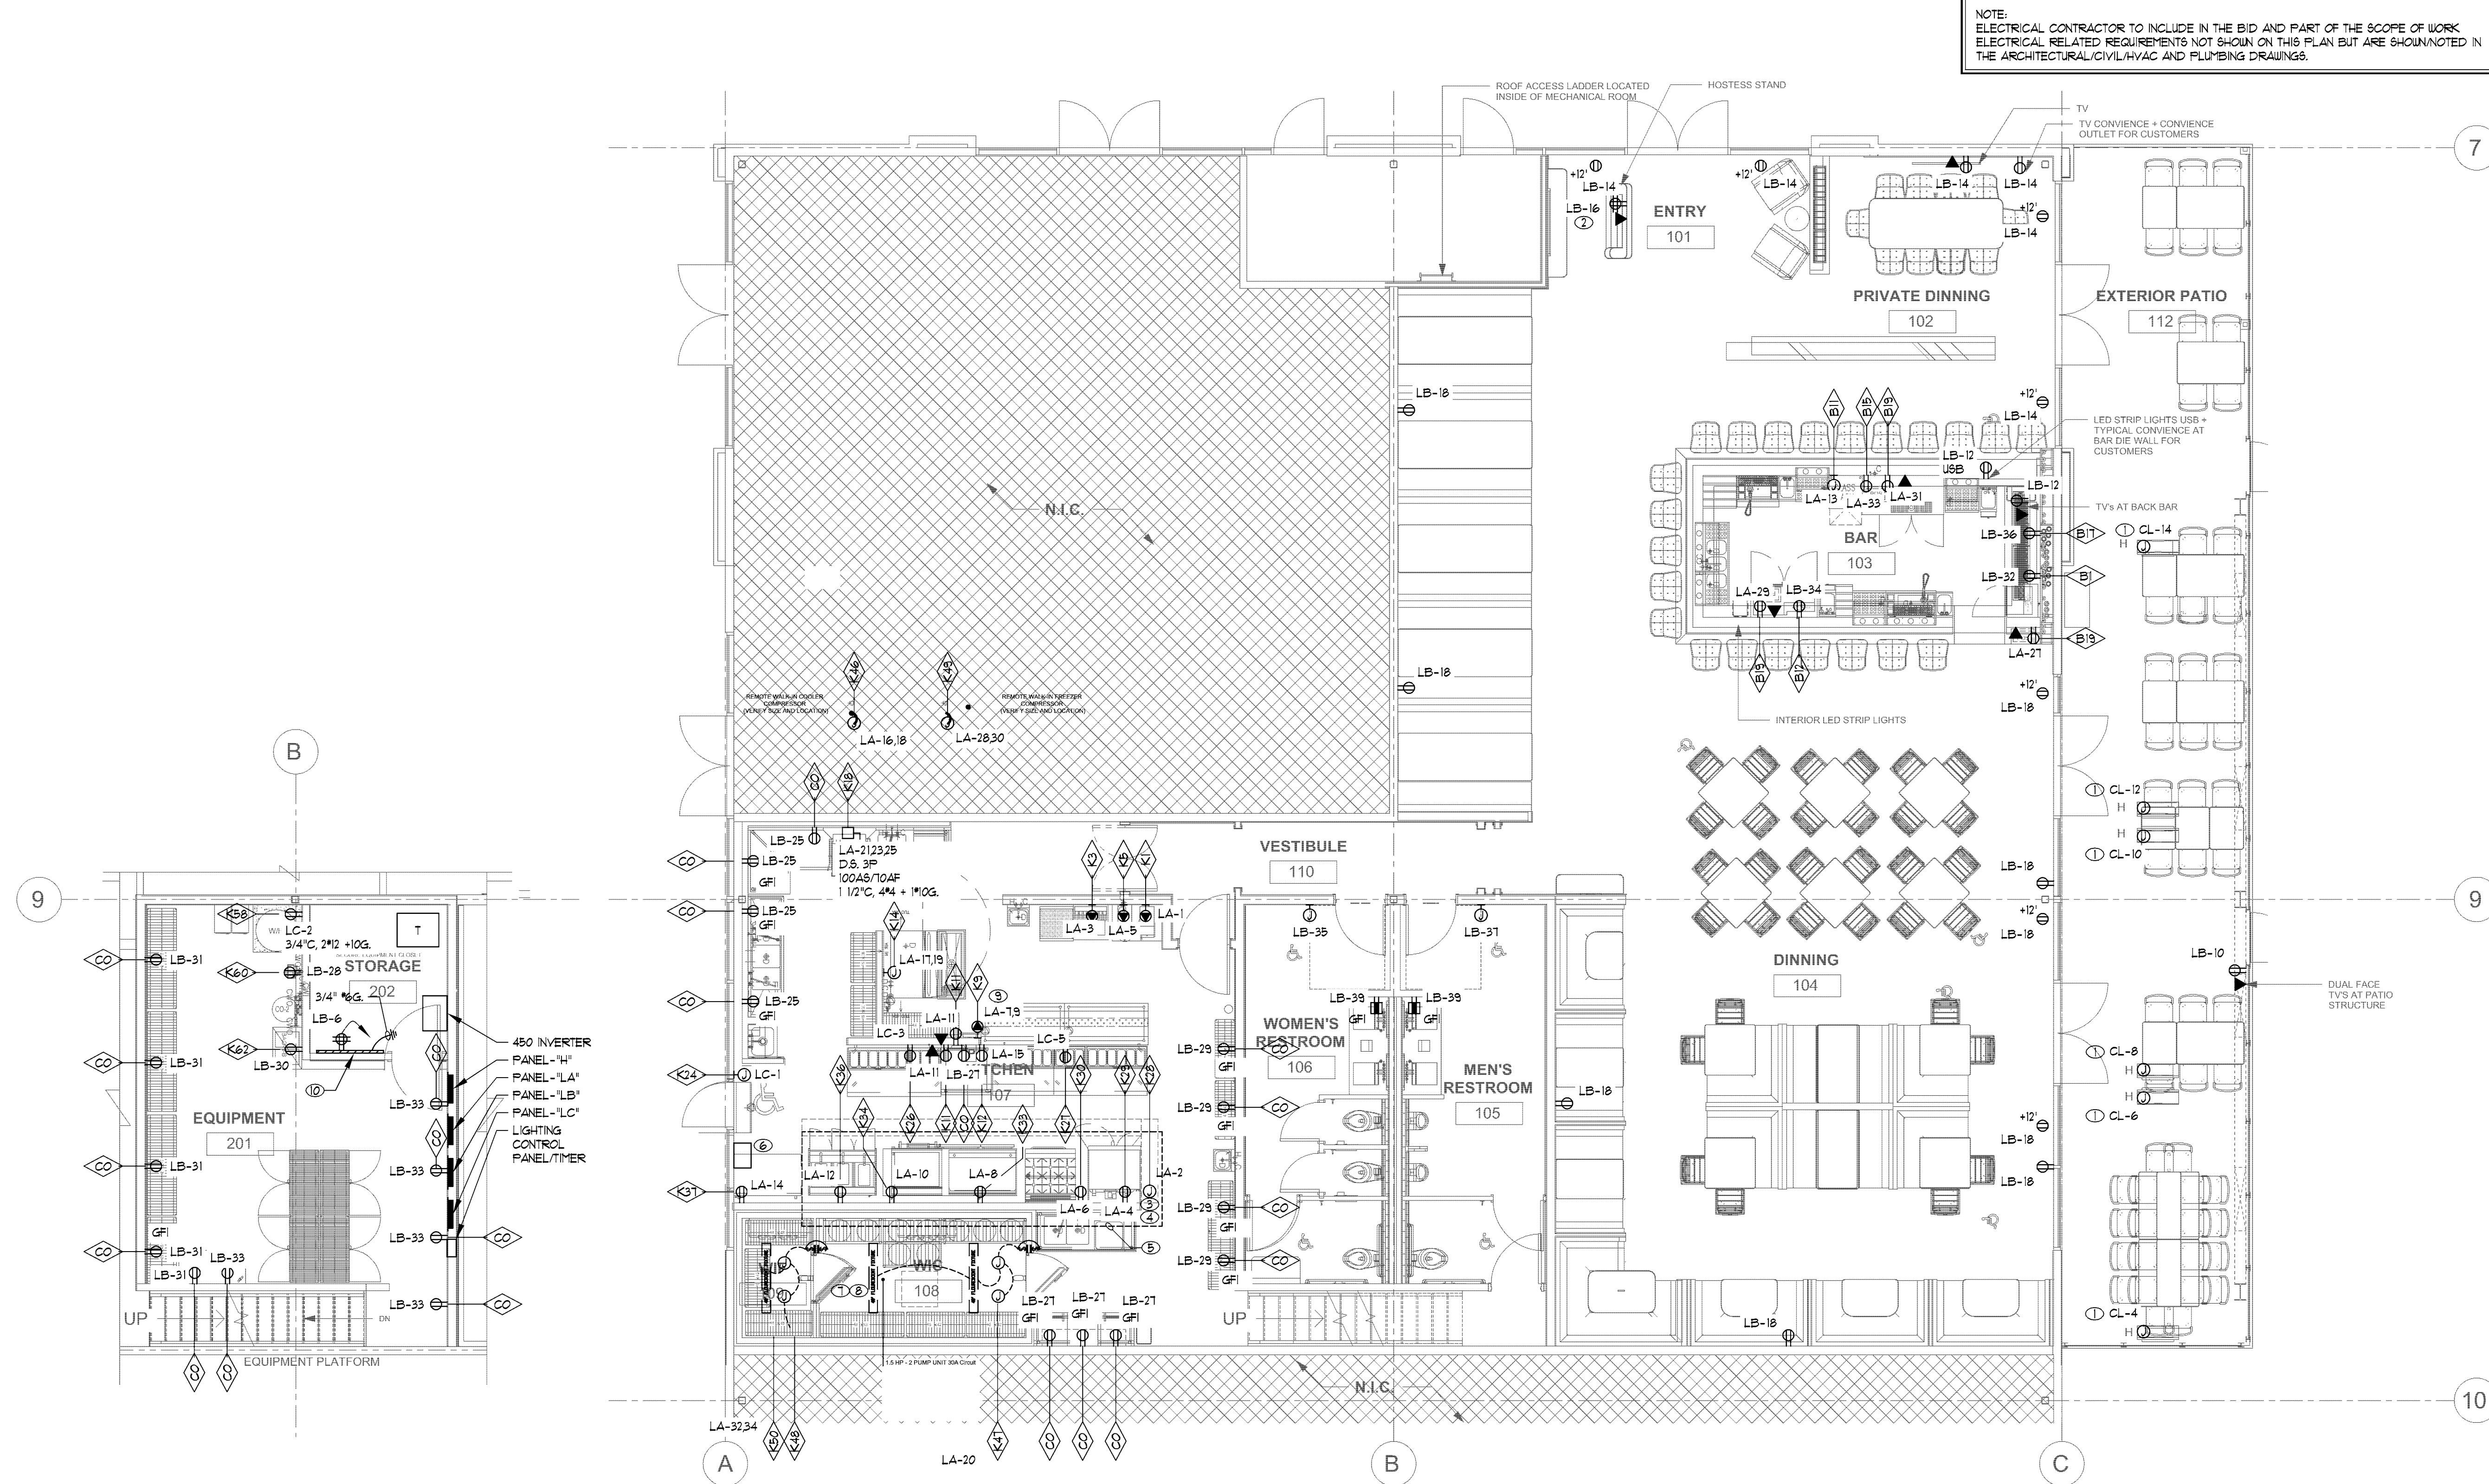

POWER PLAN - EQUIPMENT PLATFORM
SCALE: 3/16" = 1'-0"

POWER AND SIGNAL FLOOR PLAN
SCALE: 3/16" = 1'-0"

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Issue For:
Project Status
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Revisions:


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Sheet Title:
POWER AND SIGNAL FLOOR PLAN

Sheet Number:
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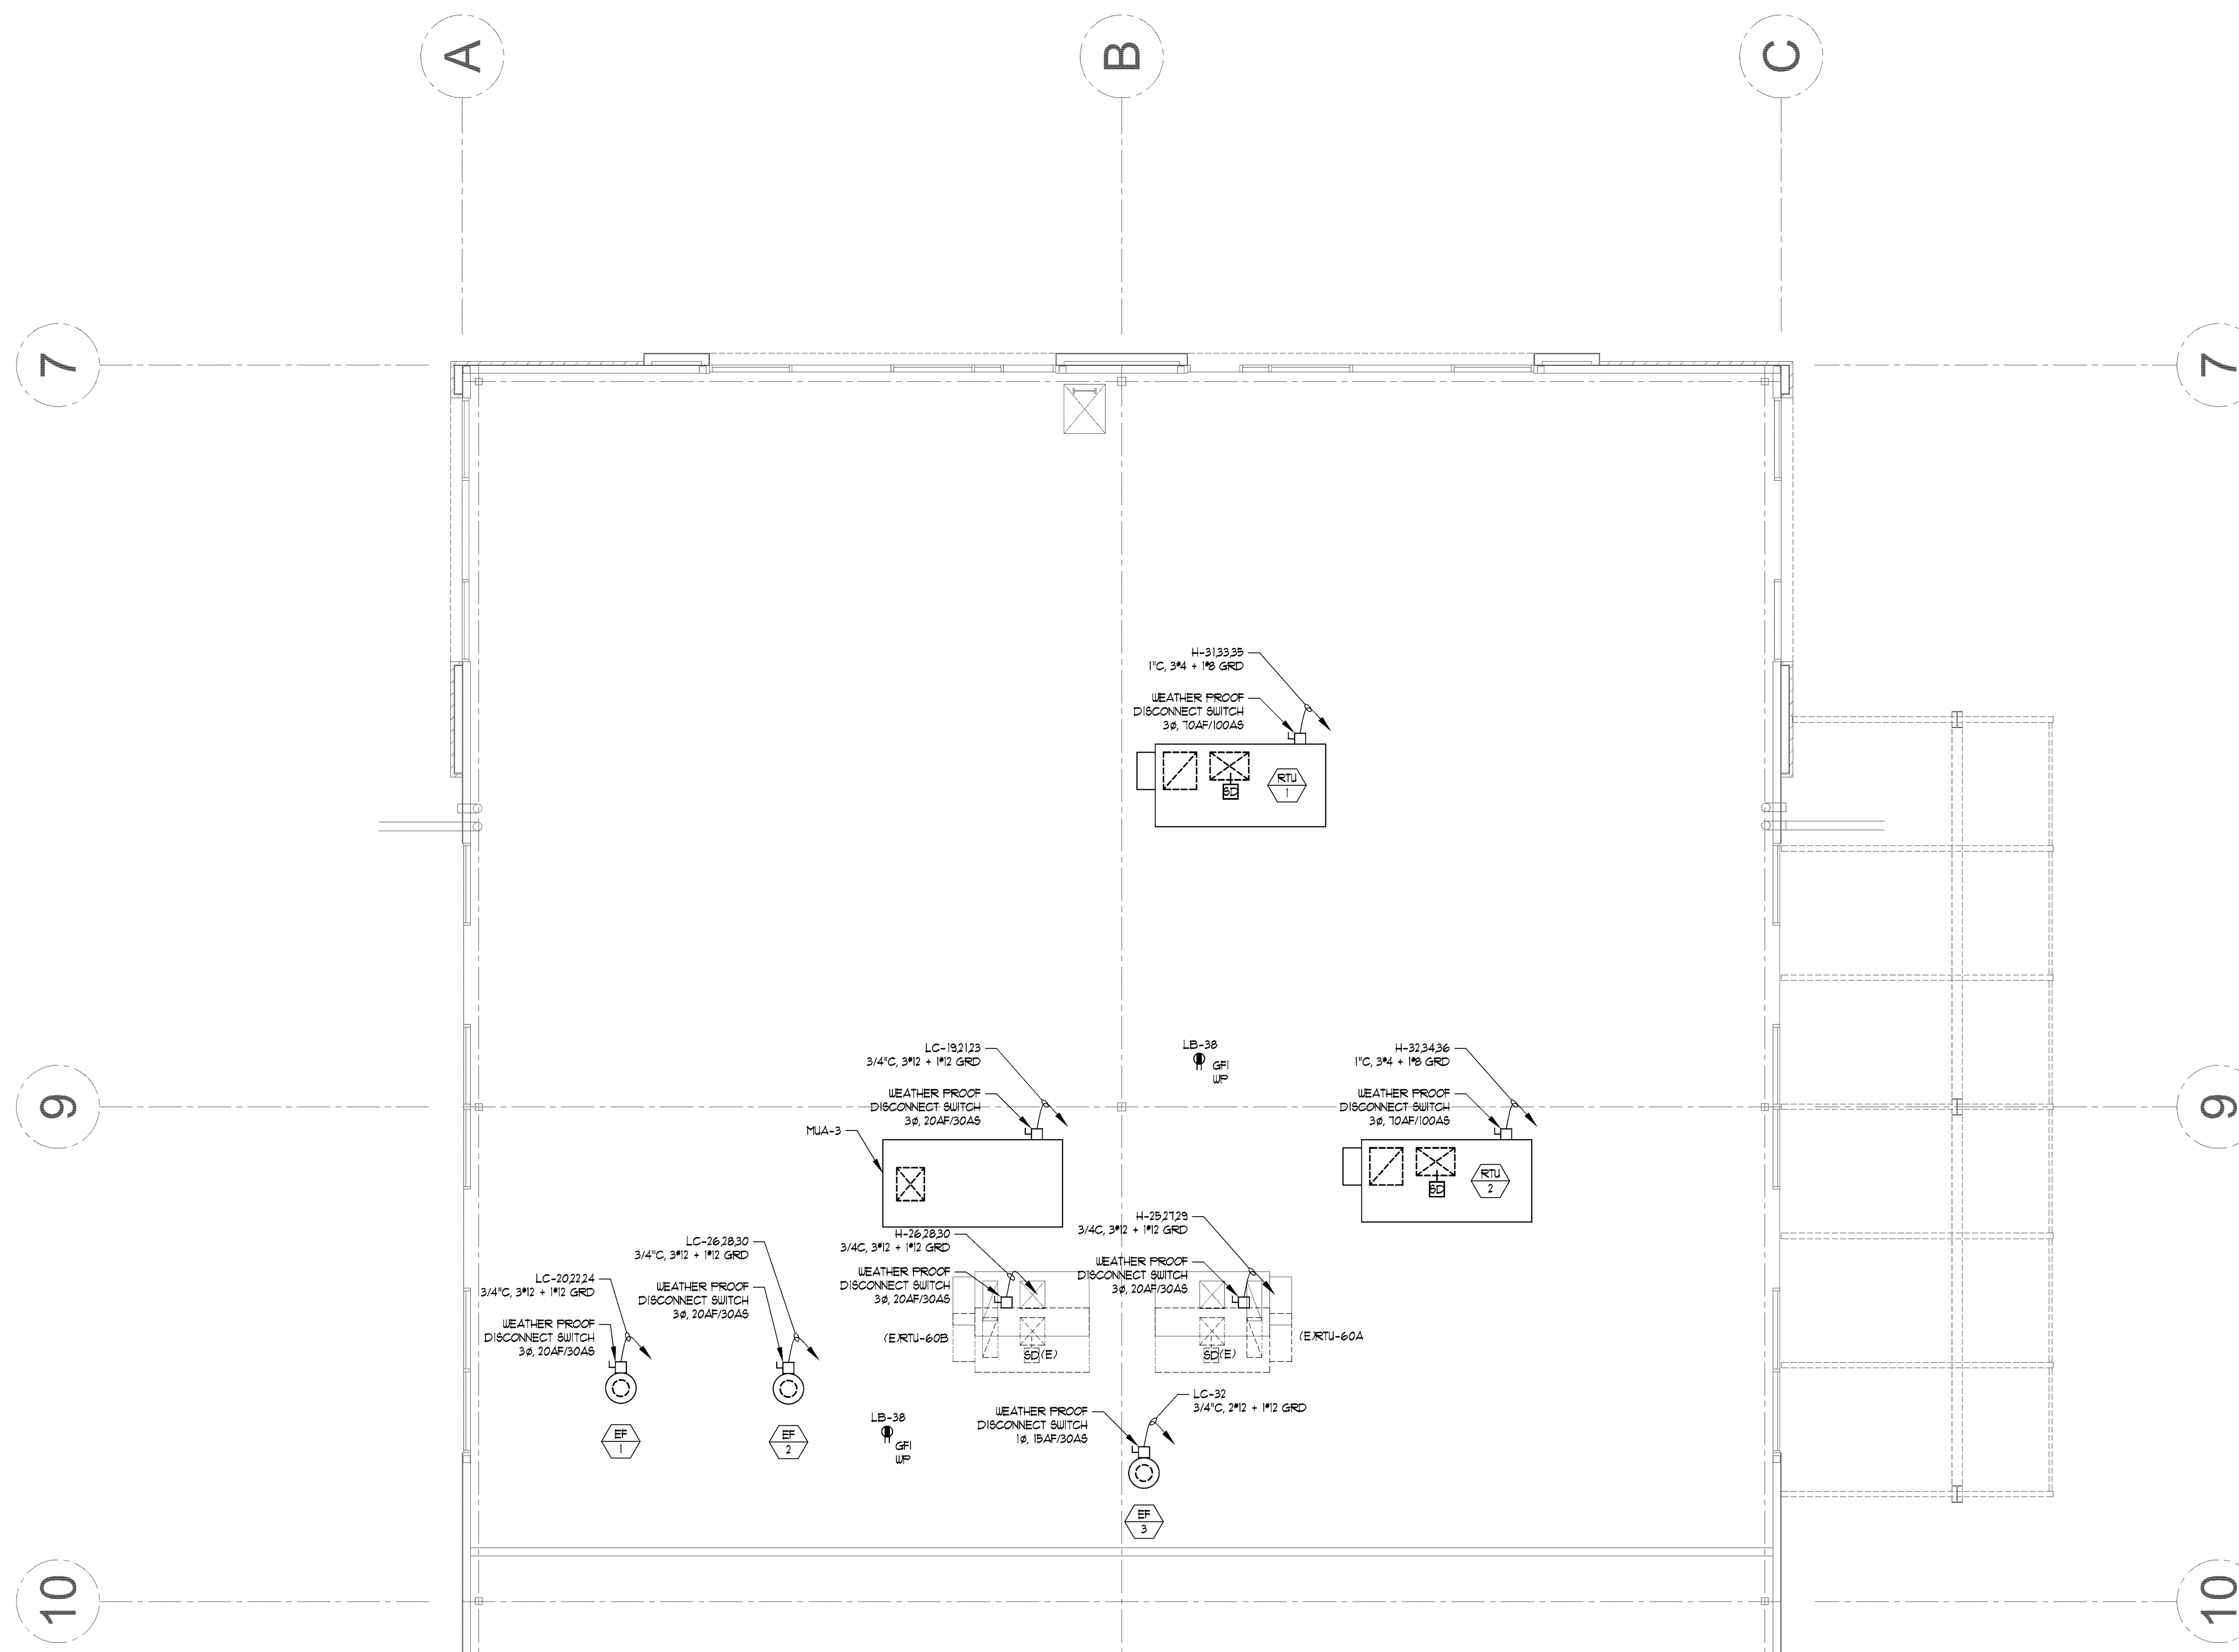


ROOF PLAN GENERAL NOTES (AS APPLICABLE)

- A. ELECTRICAL CONTRACTOR SHALL REFER TO MECHANICAL/PLUMBING AND ARCHITECTURAL DRAWINGS FOR EXACT LOCATIONS AND CHARACTERISTICS OF ALL EQUIPMENT LISTED IN SCHEDULE. ANY MODIFICATIONS AND/OR ADDITIONAL WORK NECESSARY SHALL BE INCLUDED IN THE BASE BID.
- B. ALL TEMPERATURE CONTROL AND INTERLOCK CONDUIT AND WIRING SHALL BE BY ELECTRICAL CONTRACTOR UNLESS OTHERWISE NOTED. SEE MECH/PLUMBING DRAWINGS FOR ALL INFORMATION.
- C. ELECTRICAL CONTRACTOR SHALL VERIFY THE EXACT LOCATION OF ALL CONNECTION POINTS w/ THE EQUIPMENT INSTALLER PRIOR TO ROUGH-IN.
- D. ELECTRICAL CONTRACTOR SHALL PROVIDE LOCAL REMOTE DISCONNECTING MEANS FOR ALL ELECTRIC HEATING EQUIPMENT IF REQUIRED BY THE LOCAL ELECTRICAL CODE.
- E. ELECTRICAL CONTRACTOR SHALL COORDINATE THE ROUTING OF POWER WIRING TO ROOF-MOUNTED EQUIPMENT WITHIN MECHANICAL PIPE CURB ASSEMBLY. NO SEPARATE ROOF PENETRATIONS WILL BE PERMITTED. ALL WIRING SHALL BE BELOW THE ROOF IN AN ACCESSIBLE CEILING SPACE LOCATION. FINAL CONNECTION TO ROOF EQUIPMENT WITHOUT CURB IS LIMITED TO 5'-0" OF DIRECT SOLAR EXPOSURE.
- F. PROVIDE W.P. J-BOX AND SWITCH (ONE SWITCH PER CIRCUIT INDICATED) AND CONNECT TO BUILDING MOUNTED SIGN. VERIFY EXACT LOCATION AND REQUIREMENTS w/ SIGN CONTRACTOR.
- G. ALL ROOF MOUNTED ELECTRICAL EQUIPMENT SHALL BE NEMA 3R RATED.
- H. ALL DISCONNECT SWITCHES SHALL BE HORSEPOWER RATED IN ACCORDANCE w/ NEC 430.

FOR MECHANICAL EQUIPMENT SCHEDULE REFER TO MECHANICAL DRAWINGS.

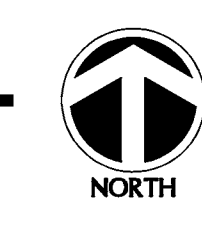NOTE: ELECTRICAL CONTRACTOR TO INCLUDE IN THE BID AND PART OF THE SCOPE OF WORK ELECTRICAL RELATED REQUIREMENTS NOT SHOWN ON THIS PLAN BUT ARE SHOWN/NOTED IN THE ARCHITECTURAL/CIVIL/HVAC AND PLUMBING DRAWINGS.



ROOF ELECTRICAL PLAN
SCALE: 3/16" = 1'-0"




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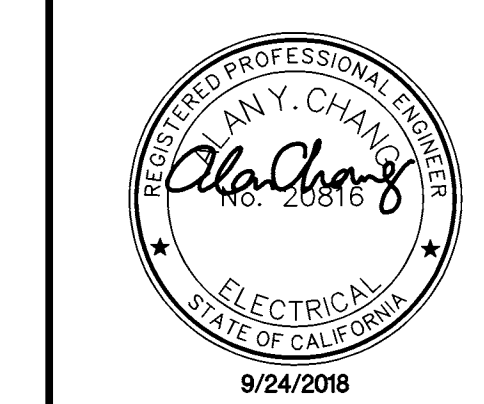
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Project Owner:



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ELECTRICAL
PLAN

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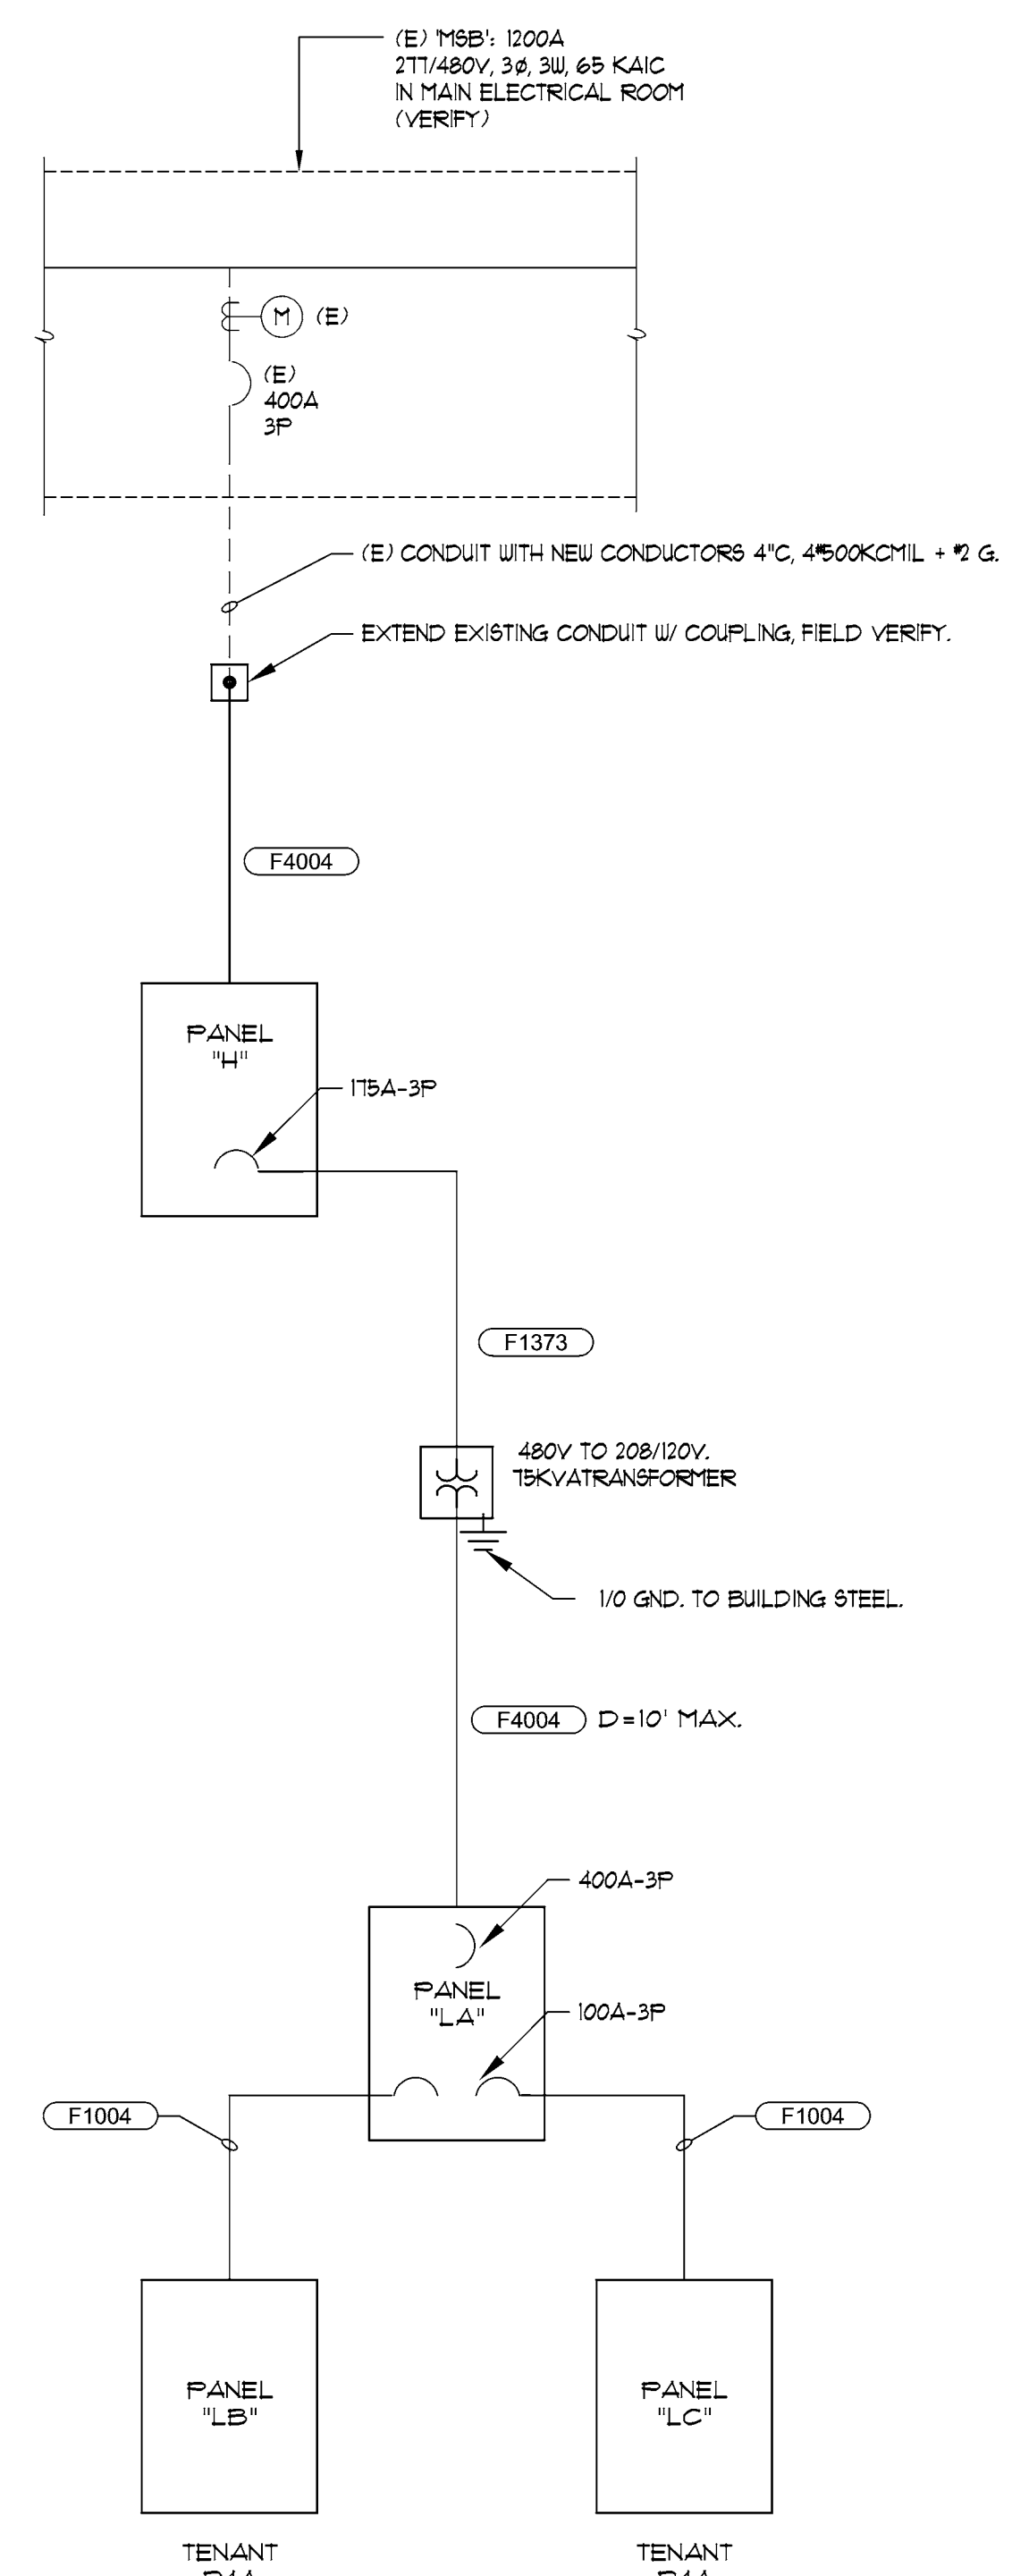
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COPPER FEEDER SCHEDULE 3ø, 4U WITH GROUND				
FEEDER	AMPS	CONDUIT	CONDUCTOR	GROUND
F204	20	3/4" C	4#12	#12
F304	30	3/4" C	4#10	#10
F404	40	3/4" C	4#8	#10
F504	50	1" C	4#6	#10
F604	60	1" C	4#4	#10
F704	70	1-1/4" C	4#4	#8
F804	80	1-1/4" C	4#2	#8
F904	90	1-1/4" C	4#2	#8
F1004	100	1-1/2" C	4#1	#8
F1254	125	2" C	4#1/0	#6
F1504	150	2" C	4#1/0	#6
F1754	175	2" C	4#1/0	#6
F2004	200	2" C	4#1/0	#6
F2254	225	2-1/2" C	4#1/0	#4
F2504	250	3" C	4#500KCMIL	#4
F4004	400	4" C	4#500KCMIL	#2
F6004	600	(2) 3" C	4#500KCMIL	#1
F8004	800	(2) 4" C	4#500KCMIL	#1/0
F10004	1000	(3) 4" C	4#500KCMIL	#1/0
F12004	1200	(4) 3" C	4#500KCMIL	#1/0
F16004	1600	(5) 4" C	4#500KCMIL	#1/0
F20004	2000	(5) 5" C	4#500KCMIL	250KCMIL
F30004	3000	(8) 5" C	4#500KCMIL	500KCMIL
F40004	4000	(10) 5" C	4#500KCMIL	500KCMIL

COPPER FEEDER SCHEDULE 3ø, 3U WITH GROUND				
FEEDER	AMPS	CONDUIT	CONDUCTOR	GROUND
F203	20	3/4" C	3#12	#12
F303	30	3/4" C	3#10	#10
F403	40	3/4" C	3#8	#10
F503	50	1" C	3#6	#10
F603	60	1" C	3#4	#10
F703	70	1" C	3#4	#8
F803	80	1-1/4" C	3#2	#8
F903	90	1-1/4" C	3#2	#8
F1003	100	1-1/4" C	3#1	#8
F1253	125	1-1/2" C	3#1/0	#6
F1503	150	1-1/2" C	3#1/0	#6
F1753	175	1-1/2" C	3#1/0	#6
F2003	200	2" C	3#1/0	#6
F2253	225	2-1/2" C	3#1/0	#4
F2503	250	2-1/2" C	3#500KCMIL	#4
F4003	400	4" C	3#500KCMIL	#2
F6003	600	(2) 3" C	3#500KCMIL	#1
F8003	800	(2) 4" C	3#500KCMIL	#1/0
F10003	1000	(3) 3" C	3#500KCMIL	#1/0
F12003	1200	(4) 3" C	3#500KCMIL	#1/0
F16003	1600	(5) 3" C	3#500KCMIL	#1/0
F20003	2000	(5) 4" C	3#500KCMIL	250KCMIL
F30003	3000	(8) 3" C	3#500KCMIL	500KCMIL
F40003	4000	(10) 4" C	3#500KCMIL	500KCMIL

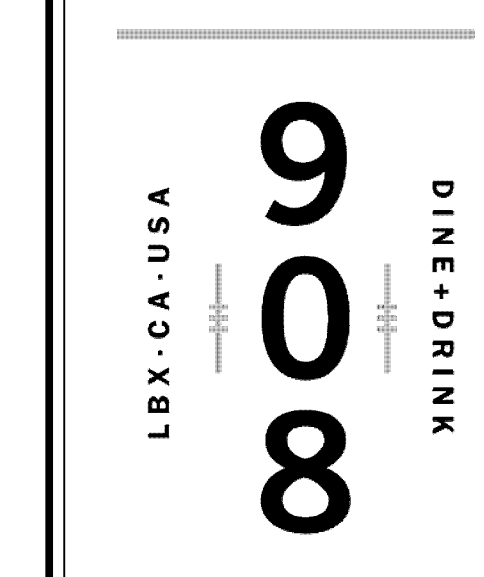
GENERAL NOTES

- ALL OVERCURRENT DEVICES IN AN INDIVIDUAL PIECE OF EQUIPMENT SHALL HAVE AN AIC RATING EQUAL TO THE OVERALL RATING OF THE EQUIPMENT - SERIES RATING OF DEVICES WITHIN A PIECE OF EQUIPMENT IS NOT ALLOWED.
- SERIES CONNECTED DEVICES SHALL HAVE BEEN INVESTIGATED BY UL IN COMBINATION WITH THE END USE EQUIPMENT, AND THE EQUIPMENT IN WHICH THESE DEVICES ARE USED SHALL BE MARKED WITH THE SERIES CONNECTED RATING. ALL EQUIPMENT SHALL BE MARKED IN ACCORDANCE WITH NEC REQUIREMENTS.
- ALL TERMINATIONS AND ENCLOSURES SHALL BE RATED FOR USE WITH 75 DEGREE CELSIUS CONDUCTORS.
- ALL SERVICE ENTRANCE EQUIPMENT, SWITCHBOARDS, DISTRIBUTION BOARDS, AND PANELBOARDS RATED AT 400 AMPS OR GREATER SHALL BE PROVIDED WITH A MAIN OVERCURRENT DEVICE AND BUSING RATED AT 100% CONTINUOUS OPERATION.
- ALL BRANCH OR FEEDER CIRCUIT OVER-CURRENT DEVICES RATED AT 400 AMPS OR HIGHER SHALL BE RATED FOR 100% CONTINUOUS OPERATION.
- CONTRACTOR SHALL SUBMIT SWITCHBOARD SHOP DRAWINGS TO THE REGULATORY UTILITY FOR APPROVAL PRIOR TO FABRICATION. CONTRACTOR SHALL SECURE CONFIRMATION THAT THE PROPOSED SWITCHBOARD COMPLIES WITH THE POWER COMPANY'S REQUIREMENTS.
- BUSING:
 - ALL BUSING SHALL BE COPPER OR ALUMINUM IN CONSTRUCTION. MAIN HORIZONTAL AND VERTICAL BUSING SHALL BE FULL CAPACITY IN ALL SWITCHBOARD SECTIONS.
 - HORIZONTAL AND VERTICAL BUSING SHALL BE FULL LENGTH. ALL BUSING SHALL HAVE A MINIMUM WITHSTAND RATING EQUAL TO THE AVAILABLE FAULT CURRENT INDICATED, BUT IN NO CASE SHALL THE RATING BE LESS THAN 65,000 AMPS, SYMMETRICAL.
- GROUND FAULT RELAY SETTINGS:
 - TO MINIMIZE NUISANCE TRIPPING OF THE MAIN AND FEEDER BREAKER, THE CONTRACTOR SHALL ADJUST THE GROUND FAULT RELAY SETTINGS FOR ALL THE GFF DEVICES TO BE HIGHER THAN ALL DOWNSTREAM GFF AND NON-GFF DEVICES. THE GROUND FAULT CURRENT PICK-UP AND THE DELAY SETTINGS SHALL BE ADJUSTED, PER THE MANUFACTURER'S RECOMMENDATIONS, RESULTING FROM A CONTRACTOR/MANUFACTURER PREPARED COORDINATION STUDY - WHICH SHALL BE DOCUMENTED IN THE SHOP DRAWING SUBMITTAL.
 - DURING THE CONSTRUCTION PHASE OF THE PROJECT, ALL GROUND FAULT RELAYS SHALL BE SET AT THE SHORTEST AVAILABLE TIME DELAY.
 - AFTER ALL SETTINGS HAVE BEEN ADJUSTED, THE CONTRACTOR SHALL HAVE THE GROUND FAULT SYSTEM TESTED BY AN INDEPENDENT TESTING AGENCY PER NEC 250-95 (G). THIS TEST SHALL BE PERFORMED IN THE PRESENCE OF THE LOCAL AUTHORITY HAVING JURISDICTION AND THE TEST RESULTS SHALL BE DELIVERED TO THE ENGINEER OF RECORD.
- DRY TYPE TRANSFORMERS: A DRY TYPE TRANSFORMERS OVER 112-12KVA SHALL HAVE A MINIMUM CLASS 155 INSULATION RATING SYSTEM. ALL DRY TYPE TRANSFORMERS SHALL BE COMPLETELY ENCLOSED EXCEPT FOR VENTILATED OPENINGS.
- EACH SERVICE DISCONNECTING MEANS AND THE EXTERIOR DOOR PROVIDING ACCESS TO THE DISCONNECTING MEANS, LOCATED IN AN APPROVED ELECTRICAL ROOM SHALL BE PERMANENTLY MARKED WITH A 1 FOOT SQUARE YELLOW SIGN WITH 1" HIGH X 1/4" STROKE BLACK LETTERING OR NUMBERS AS REQUIRED BY CODE AND THE AUTHORITY HAVING JURISDICTION.



SINGLE LINE DIAGRAM

SCALE: NONE

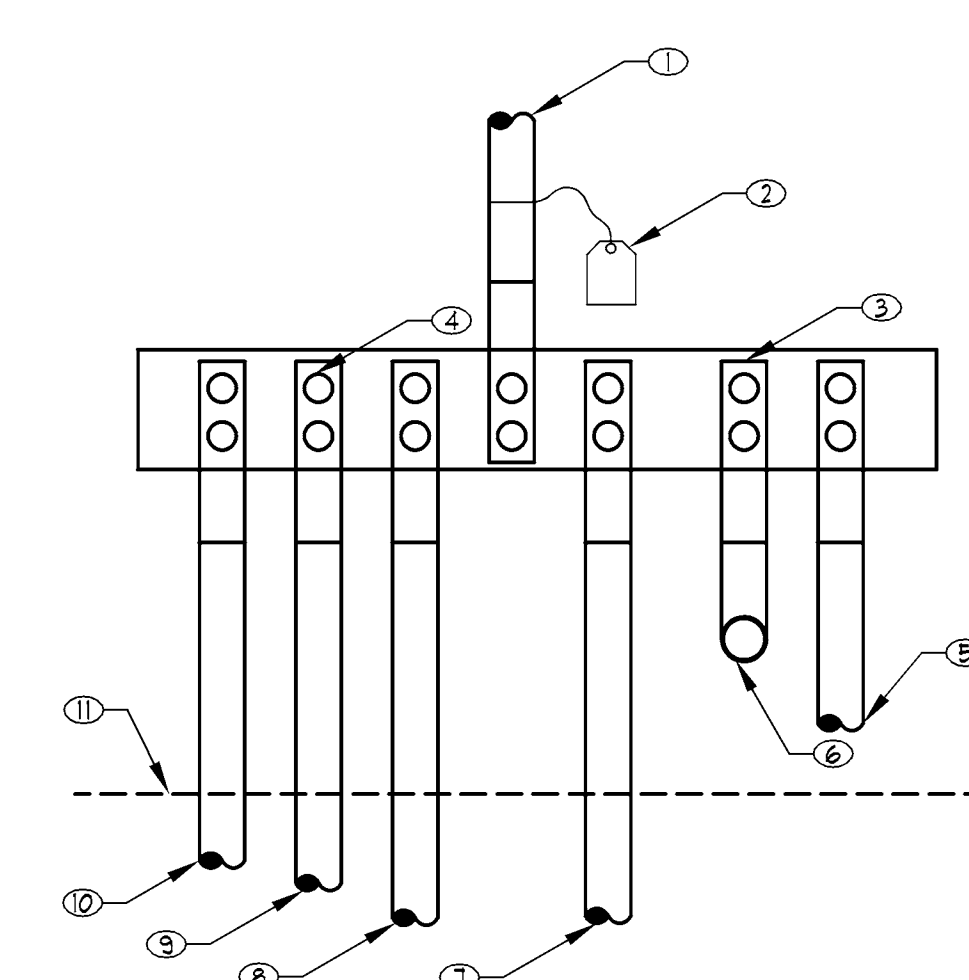

N.E.C. GROUNDING NOTES

- 1" (**) BOND JUMPER PER NEC 250.66
 - PROVIDE PERMANENT TAG TO IDENTIFY EACH CONDUCTOR.
 - 1/4" (**) LENGTH AS REQ'D. COPPER GROUND BUS DRILLED AND TAPPED AS REQ'D. BUS TO BE INSTALLED IN ELECTRICAL ROOM ADJACENT TO SUBD.
 - USE IRREVERSIBLE FASTENERS FOR CONDUCTORS LOADED ONTO BUS BAR - TYPICAL
 - 3/4" (**) (**) TO TELECOM ROOM BACKBOARDS.
 - 1/2" (**) TO UTILITY TELEPHONE/CATV BACKBOARD.
 - 1/2 BARE CU. MINIMUM TO GROUND RING PER NEC 250.52(A)(4). CONDUCTOR SHALL BE EQUAL IN SIZE TO GROUND RING CONDUCTOR AS SPECIFIED ELSEWHERE IN THESE DRAWINGS
 - 3/4" (**) (**) TO METAL UNDERGROUND WATER PIPE AND/OR INTERIOR METAL WATER PIPE WITHIN 5' OF POINT OF ENTRANCE INTO BLDG PER NEC 250.52(A)(1).
 - ONE 20FT. LENGTH OF #4 BARE COPPER ENCASED IN MIN. 2" OF CONCRETE ALL AROUND PER NEC 250.52(A)(3).
 - 3/4" (**) (**) TO EFFECTIVELY GROUND METAL FRAME OF THE BLDG. PER NEC 250-250.52(A)(2).
 - FINISHED FLOOR
- (**) COMMUNICATIONS GROUND CONDUCTOR SHALL BE SIZED BASED ON DISTANCE BETWEEN TELECOMMUNICATIONS ROOM AND SYSTEM GROUNDED BUS BAR AS FOLLOWS:
- | | |
|--------------|------|
| 0-200 FT. | #10 |
| OVER 200 FT. | #1/0 |
- (**) MAIN BONDING JUMPER SHALL BE SIZED AS FOLLOWS:
- | SERVICE SIZE | MBJ SIZE |
|--------------|----------|
| 0-1000A | #1/0 |
| 1000A | #4/0 |
| 1600A | 250KCMIL |
| 2000A | 300KCMIL |
| 2500A | 500KCMIL |
| 3000A | 500KCMIL |
| 4000A | 600KCMIL |
- (*) GROUNDING ELECTRODE CONDUCTOR SHALL BE SIZED AS FOLLOWS:
- | SERVICE SIZE | G.E.C. SIZE |
|--------------|-------------|
| 0-1000A | #4 |
| 201-400A | #1/0 |
| OVER 400A | #1/0 |
- NOTES:
- THE ELECTRICAL CONTRACTOR SHALL PROVIDE A GROUNDING ELECTRODE SYSTEM IN ACCORDANCE WITH NEC 250.52(A)(1) THROUGH (A)(6).
 - IF NONE OF THESE SYSTEMS ARE AVAILABLE, THEN THE ELECTRODES SPECIFIED IN NEC 250.52(A)(4) THROUGH (A)(7) SHALL BE PROVIDED.

MAIN SERVICE SYSTEM GROUNDING DETAIL

SCALE: NONE

NO SCALE

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 SUITE 410, BUILDING R-4
Project Number:

Sheet Title:
 SINGLE LINE
 DIAGRAM
 AND LOAD
 CALCULATIONS

Sheet Number:
 E108

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PANEL "LA"
MOUNTING RECESSED, DOUBLE LUG NO, VOLTAGE 208Y/120V, MAIN BUS 400, MLO BUS 18,000, Wires: 4
Table with columns: C I R G D S, LOCATION, TRIP AMPS, POLES, A, B, C, POLES, TRIP AMPS, DESCRIPTION, C I R G D S.

PANEL "H"
MOUNTING RECESSED, DOUBLE LUG NO, VOLTAGE 480Y/277V, MAIN BUS 400, MLO BUS 65,000, Wires: 4
Table with columns: C I R G D S, LOCATION, TRIP AMPS, POLES, A, B, C, POLES, TRIP AMPS, DESCRIPTION, C I R G D S.

PANEL "LB"
MOUNTING RECESSED, DOUBLE LUG NO, VOLTAGE 208Y/120V, MAIN BUS 200, MLO BUS 18,000, Wires: 4
Table with columns: C I R G D S, LOCATION, TRIP AMPS, POLES, A, B, C, POLES, TRIP AMPS, DESCRIPTION, C I R G D S.

PANEL "LC"
MOUNTING SURFACE, DOUBLE LUG NO, VOLTAGE 208Y/120V, MAIN BUS 100, MLO BUS 65,000, Wires: 4
Table with columns: C I R G D S, LOCATION, TRIP AMPS, POLES, A, B, C, POLES, TRIP AMPS, DESCRIPTION, C I R G D S.

GENERAL PANEL SCHEDULE NOTES:

- 1. WHERE PANEL IS INDICATED TO INCLUDE FEED THRU, LUGS, PROVIDE FEED THROUGH LUGS AT THE TOP/BOTTOM OF THE PANELBOARD FOR FEEDERS TO ANOTHER PANEL.
2. WHERE PANEL IS INDICATED TO INCLUDE DOUBLE LUGS, PROVIDE A DOUBLE LUG KIT AT THE TOP/BOTTOM OF THE PANELBOARD FOR FEEDERS TO ANOTHER PANEL.
3. WHERE PANEL IS INDICATED TO INCLUDE 100% NEUTRAL, PROVIDE PANELBOARDS UL LISTED AS HAVING NEUTRAL BUSES RATED TO CARRY 100 PERCENT OF THE CURRENT CARRYING CAPACITY OF THE PHASE BUSING.
4. WHERE PANEL IS INDICATED TO INCLUDE AN IUG BUS, PROVIDE PANELBOARDS WITH AN ISOLATED GROUND BUS, DRILLED AND TAPPED FOR NUMBER OF ISOLATED GROUND CONDUCTORS SHOWN, AS WELL AS FOR ALL SPARES AND SPACES SHOWN ON THE PANELBOARD.
5. WHERE PANEL CIRCUIT BREAKER RATING IS SHOWN AS SERIES RATED, PROVIDE CIRCUIT BREAKERS IN PANELBOARD WHICH ARE SERIES RATED WITH THE UPSHREAM SYSTEM FOR THE AVAILABLE FAULT CURRENT. THE PANELBOARD SHALL BE MARKED WITH THE SERIES CONNECTED RATINGS AS WELL AS ALL MARKING AS REQUIRED BY THE NEC, 240-83(C).
6. WHERE PANEL IS INDICATED AS RECESSED OR FLUSH MOUNTED, PROVIDE SPARE CONDUITS STUBBED UP INTO THE ACCESSIBLE CEILING SPACE, PROVIDE ONE (1) 3/4" CONDUIT ONLY FOR EACH THREE (3) SPARES OR SPACES, MINIMUM OF TWO (2). EACH CONDUIT SHALL BE TAGGED, CAPPED AND MARKED FOR FUTURE USE.
7. COORDINATE WITH APPLICABLE TRADE TO INSURE RECESSED MOUNTED PANELBOARDS WILL SEAT FLUSH IN THE WALLS PROVIDED.
8. ALL CIRCUIT BREAKERS USED AS SWITCHES SHALL BE UL LISTED AND LABELED "SW" FOR SWITCHING DUTY.
9. ALL CIRCUIT BREAKERS USED TO SERVE MECHANICAL OR HEATING EQUIPMENT SHALL BE UL LISTED AND LABELED "HACR" FOR USE WITH THESE LOADS, WHERE REQUIRED.
10. ALL CIRCUIT BREAKERS SHALL BE BOLT-ON TYPE. BREAKERS IN LOAD CENTERS FOR DUPELLING UNITS CAN BE PLUG-IN TYPE.
11. PROVIDE SHOP DRAWING SUBMITTAL PER THE ELECTRICAL SPECIFICATION SUBMITTAL REQUIREMENTS FOR EACH PANEL, DEPICTING CONFORMANCE WITH THE ABOVE NOTES AND SCHEDULES.

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ELECTRICAL PANEL SCHEDULES

Sheet Number:
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E109-817463C

